Egremont Free Library / Mount Everett Academy Stabilization & ADA Improvements Project

1 Buttonball Lane - South Egremont, Massachusetts

Date: October 7, 2021

OWNER

Town of Egremont 171 Egremont Plain Road Egremont, MA 01258

Phone: 413-528-0182

ARCHITECT

Evelyn Cole Smith Architects, LLC 77 Child Hill Road Woodstock, CT 06281

Phone: 860-377-9338

MEP ENGINEER

Salamone & Associates, P.C. 116 North Plains Industrial Road Wallingford, CT 06492

Phone: 203-281-6895

GENERAL NOTES

- I. CONTRACTOR SHALL REVIEW CONSTRUCTION DOCUMENTS AND EXISTING CONDITIONS PRIOR TO SUBMITTING A COST
- 2. ALL WORK IS TO BE PERFORMED IN STRICT ACCORDANCE WITH THE NATIONAL PARK SERVICE, SECRETARY OF THE INTERIOR'S STANDARDS FOR THE TREATMENT OF HISTORIC PROPERTIES.
- 3. PROTECT EXISTING MATERIALS OUTSIDE OF THE SCOPE OF STABILIZATION, AND REPAIR IN KIND IF DAMAGED.
- 4. MAINTAIN THE BUILDING IN WEATHERTIGHT CONDITION THROUGHOUT THE CONSTRUCTION PHASE.
- 5. REPAIR WOOD WHERE THE DETERIORATION REPRESENTS LESS THAN 25% OF THE MATERIAL
- A) INJECT WOOD CONSOLIDANT AS APPROVED BY THE ARCHITECT
- 6. REPLACE WOOD FABRIC WHERE DETERIORATION REPRESENTS 25% OR MORE OF THE MATERIAL.
 - A) REPLACE WOOD IN-KIND TO THE GREATEST EXTENT POSSIBLE. B) MATCH DIMENSIONS AND PROFILES OF EXISTING MATERIALS.
- 7. CONTRACTOR TO PREPARE A WORK PLAN FOR SHORING, JACKING AND EXCAVATION FOR REVIEW BY THE ARCHITECT PRIOR TO CARRYING OUT THIS WORK.

FRAMING STABILIZATION

- REMOVE AND RETAIN CARPET AND WOOD FLOORING IN THE AREAS SHOWN ON THE DRAWING IN ORDER TO PROVIDE ACCESS TO THE CRAWL SPACE FOR INSTALLATION OF NEW PIERS AND FOR REPAIR OF FLOOR FRAMING. SEE ALTERNATE ONE FOR
- 2. INSTALL NEW PIERS UNDER EXISTING FIRST FLOOR MAIN BEAMS ALIGNING WITH THE BELFRY FRAMING TO PROVIDE A CONTINUOUS LOAD PATH. CMU TO CONFORM TO ASTM C-90.
- 3. DOCUMENT EXISTING CONDITION OF FLOOR FRAMING IN AREAS NOTED ON THE DRAWINGS FOR REVIEW BY THE ARCHITECT. REPAIR FRAMING / JOINTS AS DIRECTED BY THE ARCHITECT. REPAIR WILL BE WITH CONSOLIDANT, BY THE INSTALLATION OF DUTCHMAN, OR WITH METAL CONNECTORS AS APPROPRIATE TO ADDRESS THE CONDITION OF THE POSTS (2). THE MAXIMUM AMOUNT OF EXISTING FRAMING IS TO BE RETAINED.
- 4. REPOINT THE STONE FOUNDATION.
- A) TEST EXISTING MORTAR FOR STRENGTH AND COMPOSITION AS SPECIFIED FOR REPOINTING ACCORDING TO ASTM C-1234-03 STANDARD TEST METHOD FOR EXAMINATION & ANALYSIS OF HARDENED MASONRY MORTAR BY QUALIFIED
- B) REPLACE MISSING AND DISPLACED FOUNDATION STONES.
- C) REMOVE EXISTING MORTAR TO FIRM SUBSTRATE USING HAND TOOLS ONLY.
- D) PROVIDE A MOCK-UP OF NEW MORTAR SAMPLE FOR REVIEW AND APPROVAL BY THE ARCHITECT.
- E) INSTALL APPROVED MORTAR IN I" LIFTS AND TOOL FINISHED SURFACE TO MATCH HISTORIC MORTAR JOINT.
- 5. INSTALL DUCT INSULATION ON SHEET METAL DUCTS IN THE CRAWLSPACE. INSULATE SHEET METAL DUCTWORK WITH FLEXIBLE FIBERGLASS DUCTWORK INSULATION CONFORMING TO ASTM C-553, TYPE I, CLASS B-4 WITH ALL STAPLES, BANDS, WIRES, TAPE, ANCHORS, CORNER ANGLES AND SIMILAR ACCESSORIES AS RECOMMENDED BY THE INSULATION MANUFACTURER.
- 6. REPAIR WEB AT ATTIC TRUSS. THE WEB ON THE EASTERN TRUSS HAS BEEN CUT OUT TO PROVIDE ACCESS TO THE REAR OF THE STRUCTURE. THE CUT OUT WEB MEMBER, WITH TENON INTACT IS LYING ON THE CEILING JOISTS IN THE ATTIC AND CAN BE REINSTALLED BY INSERTING THE TENON INTO THE KINGPOST MORTISE AND PEGGING IN PLACE, AND INSTALLING METAL STRAPS, ON EITHER SIDE OF THE WEB AND THRU BOLTING. SHOP DRAWINGS ARE TO BE SUBMITTED TO THE OWNER FOR REVIEW BY A LICENSED STRUCTURAL ENGINEER.
- 7. INSTALL 6 MIL POLY VAPOR BARRIER AND 2" RAT SLAB IN CRAWLSPACE.

ROOFING AND FLASHING AT BELFRY FLOOR LEVEL

- CAREFULLY REMOVE LOUVER PANELS FROM ALL BELFRY FACADES MARKING THEM DISCREETLY FOR REINSTALLATION IN SAME LOCATION. INSTALL STAINLESS STEEL INSECT SCREEN ON THE REAR OF THE LOUVER FRAME. REINSTALL LOUVERS AFTER COMPLETION OF ROOFING AND FLASHING PROJECT.
- 2. CAREFULLY REMOVE EXTERIOR TRIM FROM ALL CORNER POSTS, INCLUDING THE ENGAGED COLUMNS AND BACK UP TRIM, FROM THE BELFRY FLOOR LEVEL TO THE FASCIA ABOVE, MARKING EACH PIECE DISCREETLY FOR REINSTALLATION IN THE SAME LOCATION. REMOVE THE MINIMUM MATERIAL POSSIBLE, AT EXISTING CONSTRUCTION JOINTS, TO ACCESS THE BASE OF THE BELFRY POSTS FOR THE INSTALLATION OF NEW FLASHING, COUNTERFLASHING
- 3. REMOVE AND DISPOSE OF EXISTING ASPHALT COMPOSITION ROOFING, METAL DRIP EDGE AND ANY UNDERLAYMENT FOUND ON THE EXTERIOR ROOF AND FROM THE INTERIOR OF THE BELFRY FLOOR LEVEL.
- 4. REMOVE METAL FLASHING AND ASPHALT ROOFING CEMENT FROM NW POST BASE AND DOCUMENT EXISTING CONDITIONS FOR REVIEW BY THE ARCHITECT. REPAIR POST BASES AS DIRECTED BY THE ARCHITECT. REPAIR WILL BE WITH CONSOLIDANT OR BY THE INSTALLATION OF DUTCHMAN AS APPROPRIATE TO ADDRESS THE CONDITION OF THE POSTS.
- 5. REMOVE WATER DAMAGED SHEATHING AND REPLACE IN KIND. ASSUME 20 SF OF SHEATHING REPLACEMENT. PREPARE SURFACE FOR INSTALLATION OF NEW ROOFING FELT, ROSIN PAPER, FLASHING AND FLAT LOCK COPPER ROOF SYSTEM.
- 6. INSTALL NEW 30 LB. ROOFING FELT AND ROSIN PAPER OVER THE ENTIRE EXTERIOR WASH SURFACE AND THE INTERIOR
- INSTALL 16 OZ. COPPER FLASHING AT BASE OF BELFRY WALL TO 8" ABOVE FLOOR SURFACE AT WALL AND AROUND THE
- 8. INSTALL A FLAT LOCK, CLEATED SEAM 16 OZ. COPPER ROOF AT THE BELFRY WASH LEVEL, EXTENDING THE ROOFING TO THE INTERIOR OF THE BELFRY. INSTALL SHEET COPPER MATERIAL ROOF ON THE EXTERIOR FACE OF THE FLOOR HATCH SO THAT IT REMAINS A SEPARATE OPERABLE ELEMENT. INSTALLATION TO BE IN ACCORDANCE WITH SMACNA'S "ARCHITECTURAL SHEET METAL MANUAL, SEVENTH EDITION".
- 9. PREPARE REINSTALLED TRIM AND LOUVERS FOR PAINT. PRIME & PAINT, BY BRUSH APPLICATION, TWO FINISH COATS OF SATIN FINISH EXTERIOR LATEX ENAMEL AS MANUFACTURED BY BENJAMIN MOORE, SHERWIN WILLIAMS, DURON OR APPROVED EQUAL. SUBMIT PRODUCT DATA FOR ARCHITECT'S APPROVAL

- REMOVE EXISTING TOILET ROOM FIXTURES AND INSTALL NEW ADA COMPLIANT FIXTURES & ACCESSORIES. MODIFY PLUMBING
- 2. INSTALL NEW RAISED FLOOR SYSTEM IN REAR ADDITION TO ALIGN WITH MAIN FLOOR LEVEL.
- 3. INSTALL NEW EXTERIOR WOOD RAMP SYSTEM, STAIR, AND RAILINGS.
- 4. INSTALL NEW CONCRETE WALKS ASSOCIATED WITH NEW STAIR & RAMP.
- 5. INSTALL NEW PAVED PARKING AREA AND SIGNAGE.
- 6. MODIFY REAR ENTRANCE DOOR & ROOF TO ACCOMMODATE NEW FLOOR HEIGHT.
- 7. RELOCATE THE EXISTING ELECTRICAL PANEL. IN CONJUNCTION WITH ADA IMPROVEMENTS, RELOCATE THE ELECTRIC PANEL

DRAWING LIST

PME-3 Plumbing / Mechanical / Electrical Details, Notes, Schedules, Symbols Abbreviations

#I CARPETING

REMOVE & DISPOSE OF EXISTING CARPETING AND PAD. INSTALL NEW TUFTED BROADLOAM, 26 OZ. SOLUTION DIED, CLASS I CARPET. DO NOT DIRECT GLUE PRODUCT. USE TACK STRIPS.

#2 FIRE PROTECTION

Title Sheet

I. INSTALL NEW FIRE PROTECTION DEVICES & SYSTEMS AS DESCRIBED ON THE MEP DRAWINGS.

I. PROVIDE & INSTALL NEW LIGHTING AS DESCRIBED ON THE MEP DRAWINGS

Floor Plans, Details, & Schedules


Roof Plan, Elevations, Details, & Belfry Details

Plumbing / Mechanical / Electrical Plans

Plumbing / Mechanical / Electrical Attic Plan

Plumbing / Mechanical / Electrical Demolition Plans

Toilet Room Enlarged Plan & Interior Elevations, & Schedules

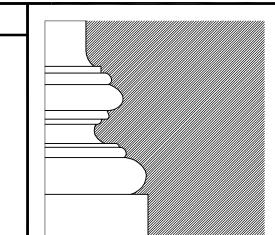

EVELYN COLE SMITH ARCHITECTS, LLC

77 Child Hill Rd Woodstock, CT 860 377 9338

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STAMP

RESERVED

PROJECT

Stabilization & ADA Improvements

Mount Everett Academy

1 Buttonball Lane S. Egremont, MA 01230

Prepared for

Town of Egremont 171 Egremont Plain Road

Egremont, MA 01258 (413) 528-0182

REVISIONS

Description

Title Sheet

SHEET TITLE


PROJ. NO. 2019027 SCALE AS NOTED


DATE October 7, 2021 DESIGNED LYN SMITH, AIA, LEED A

DRAWN CLINTON RICHMOND

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1 OF 8



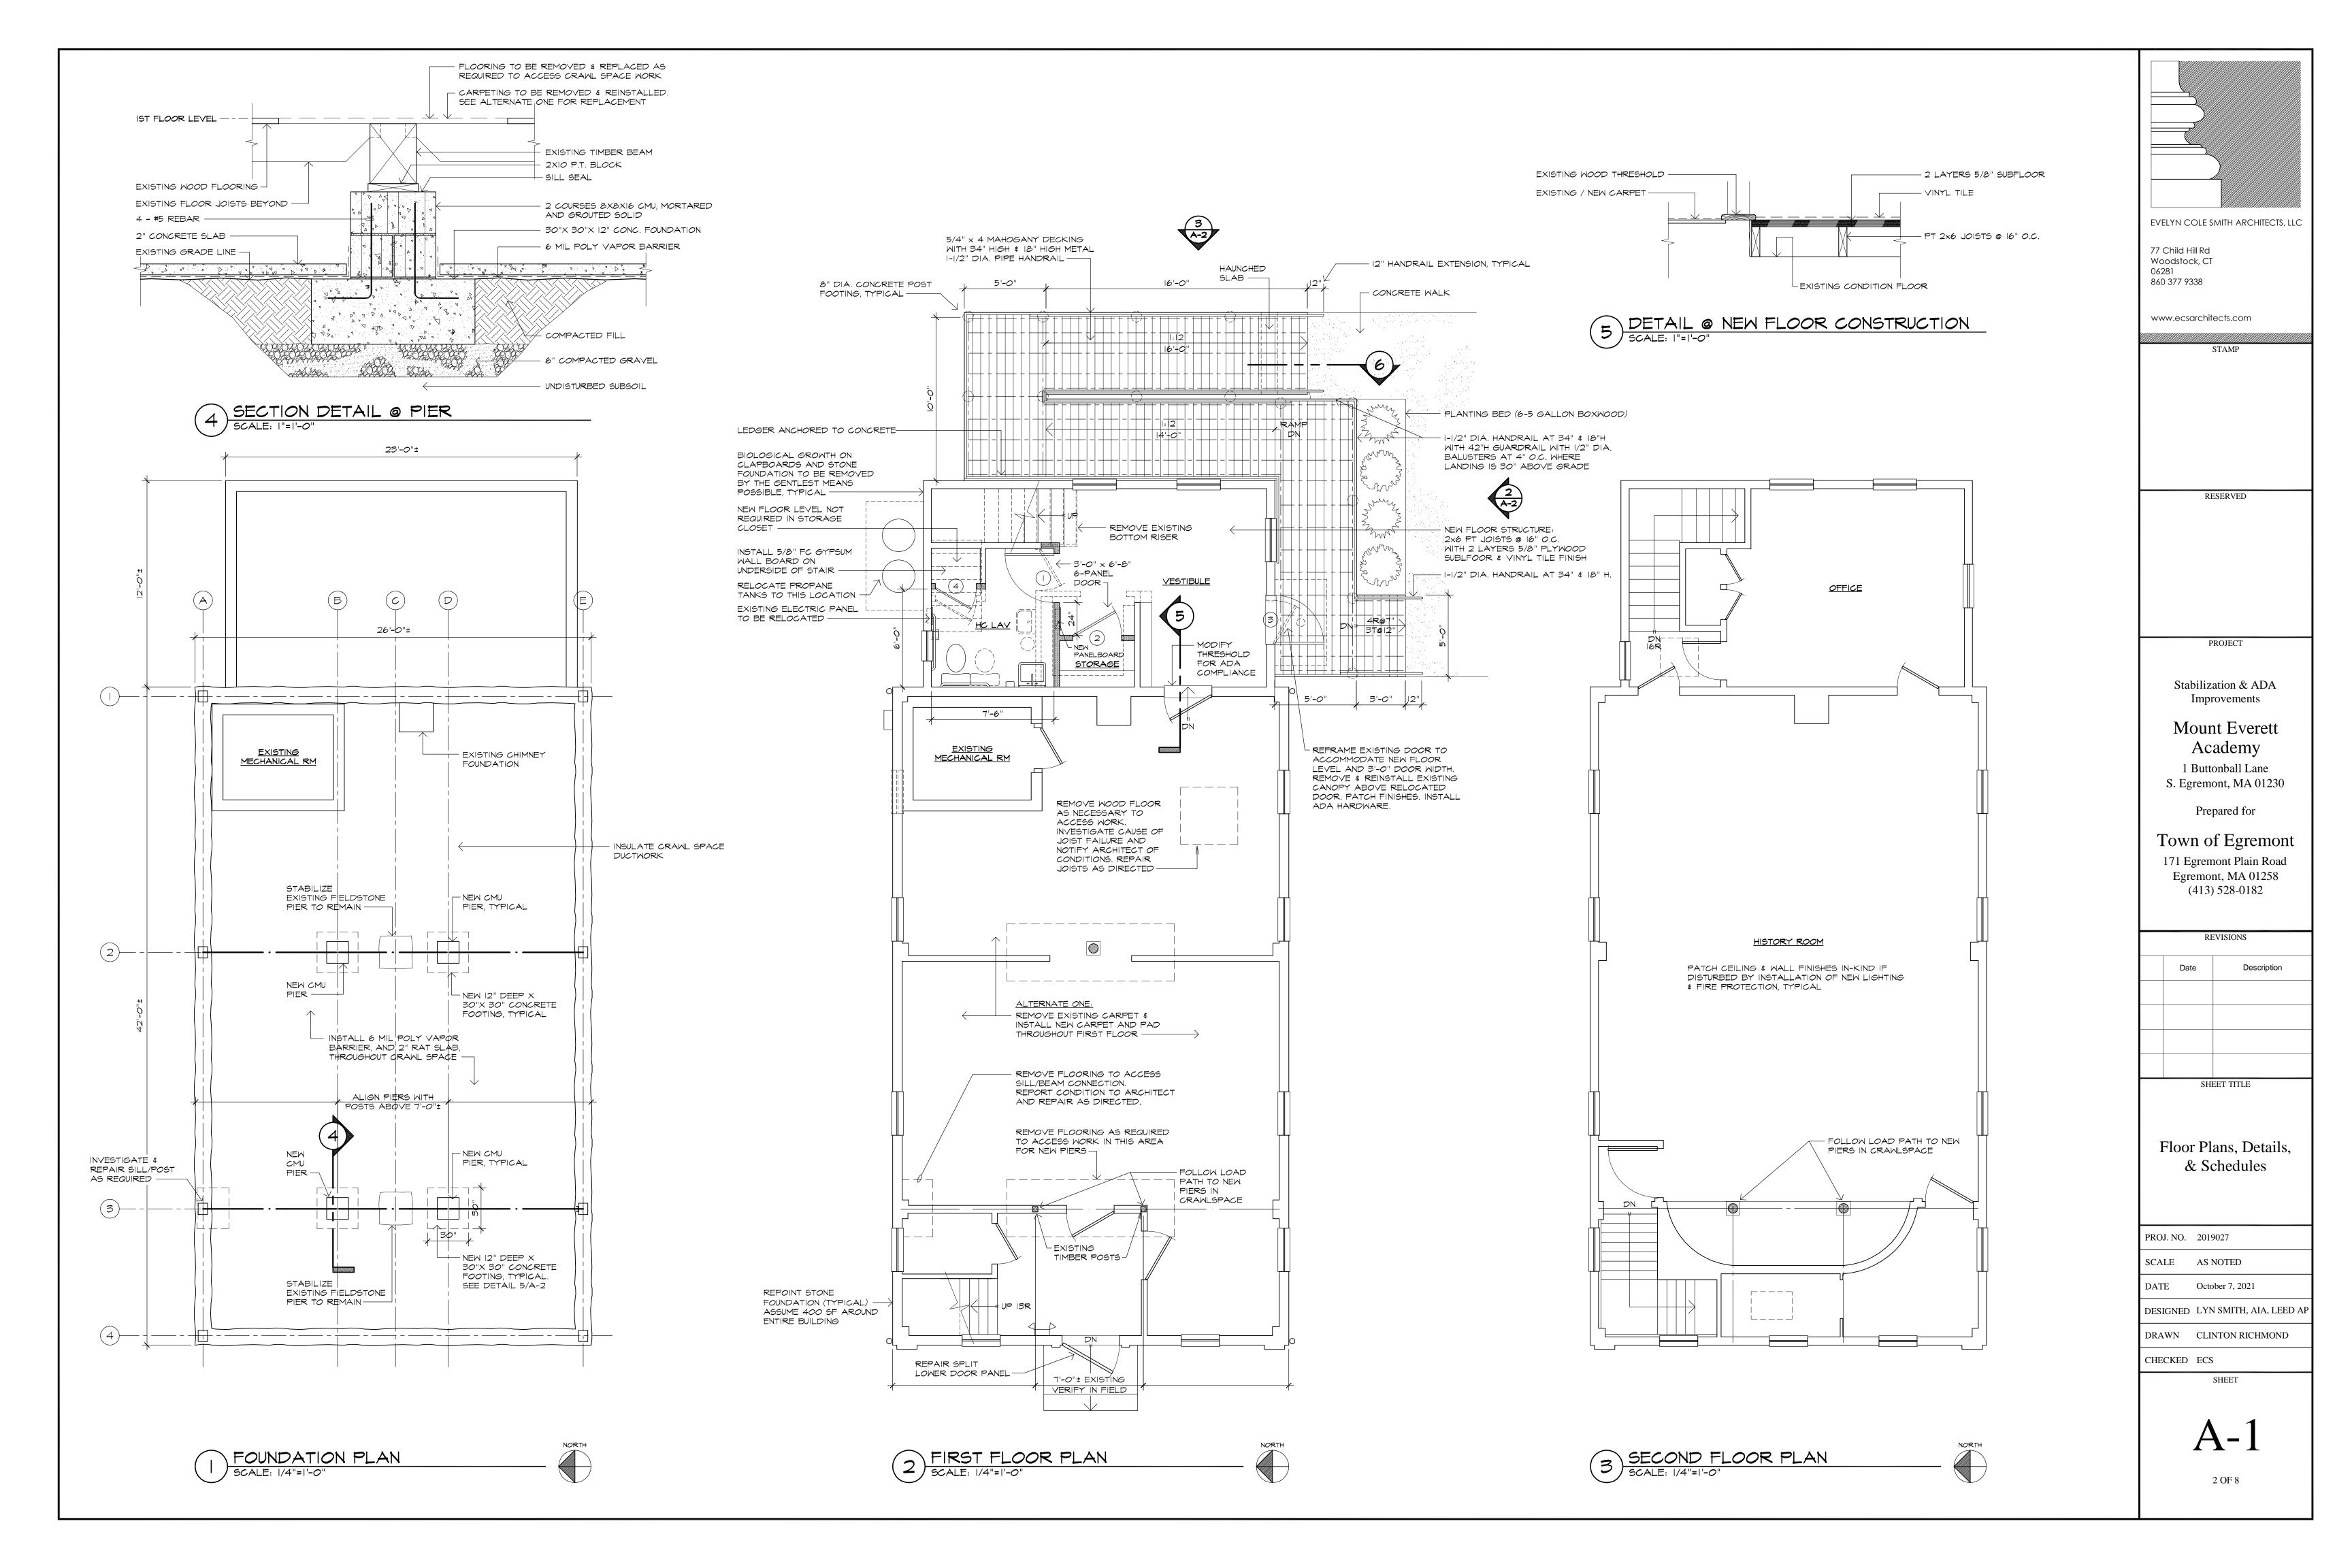

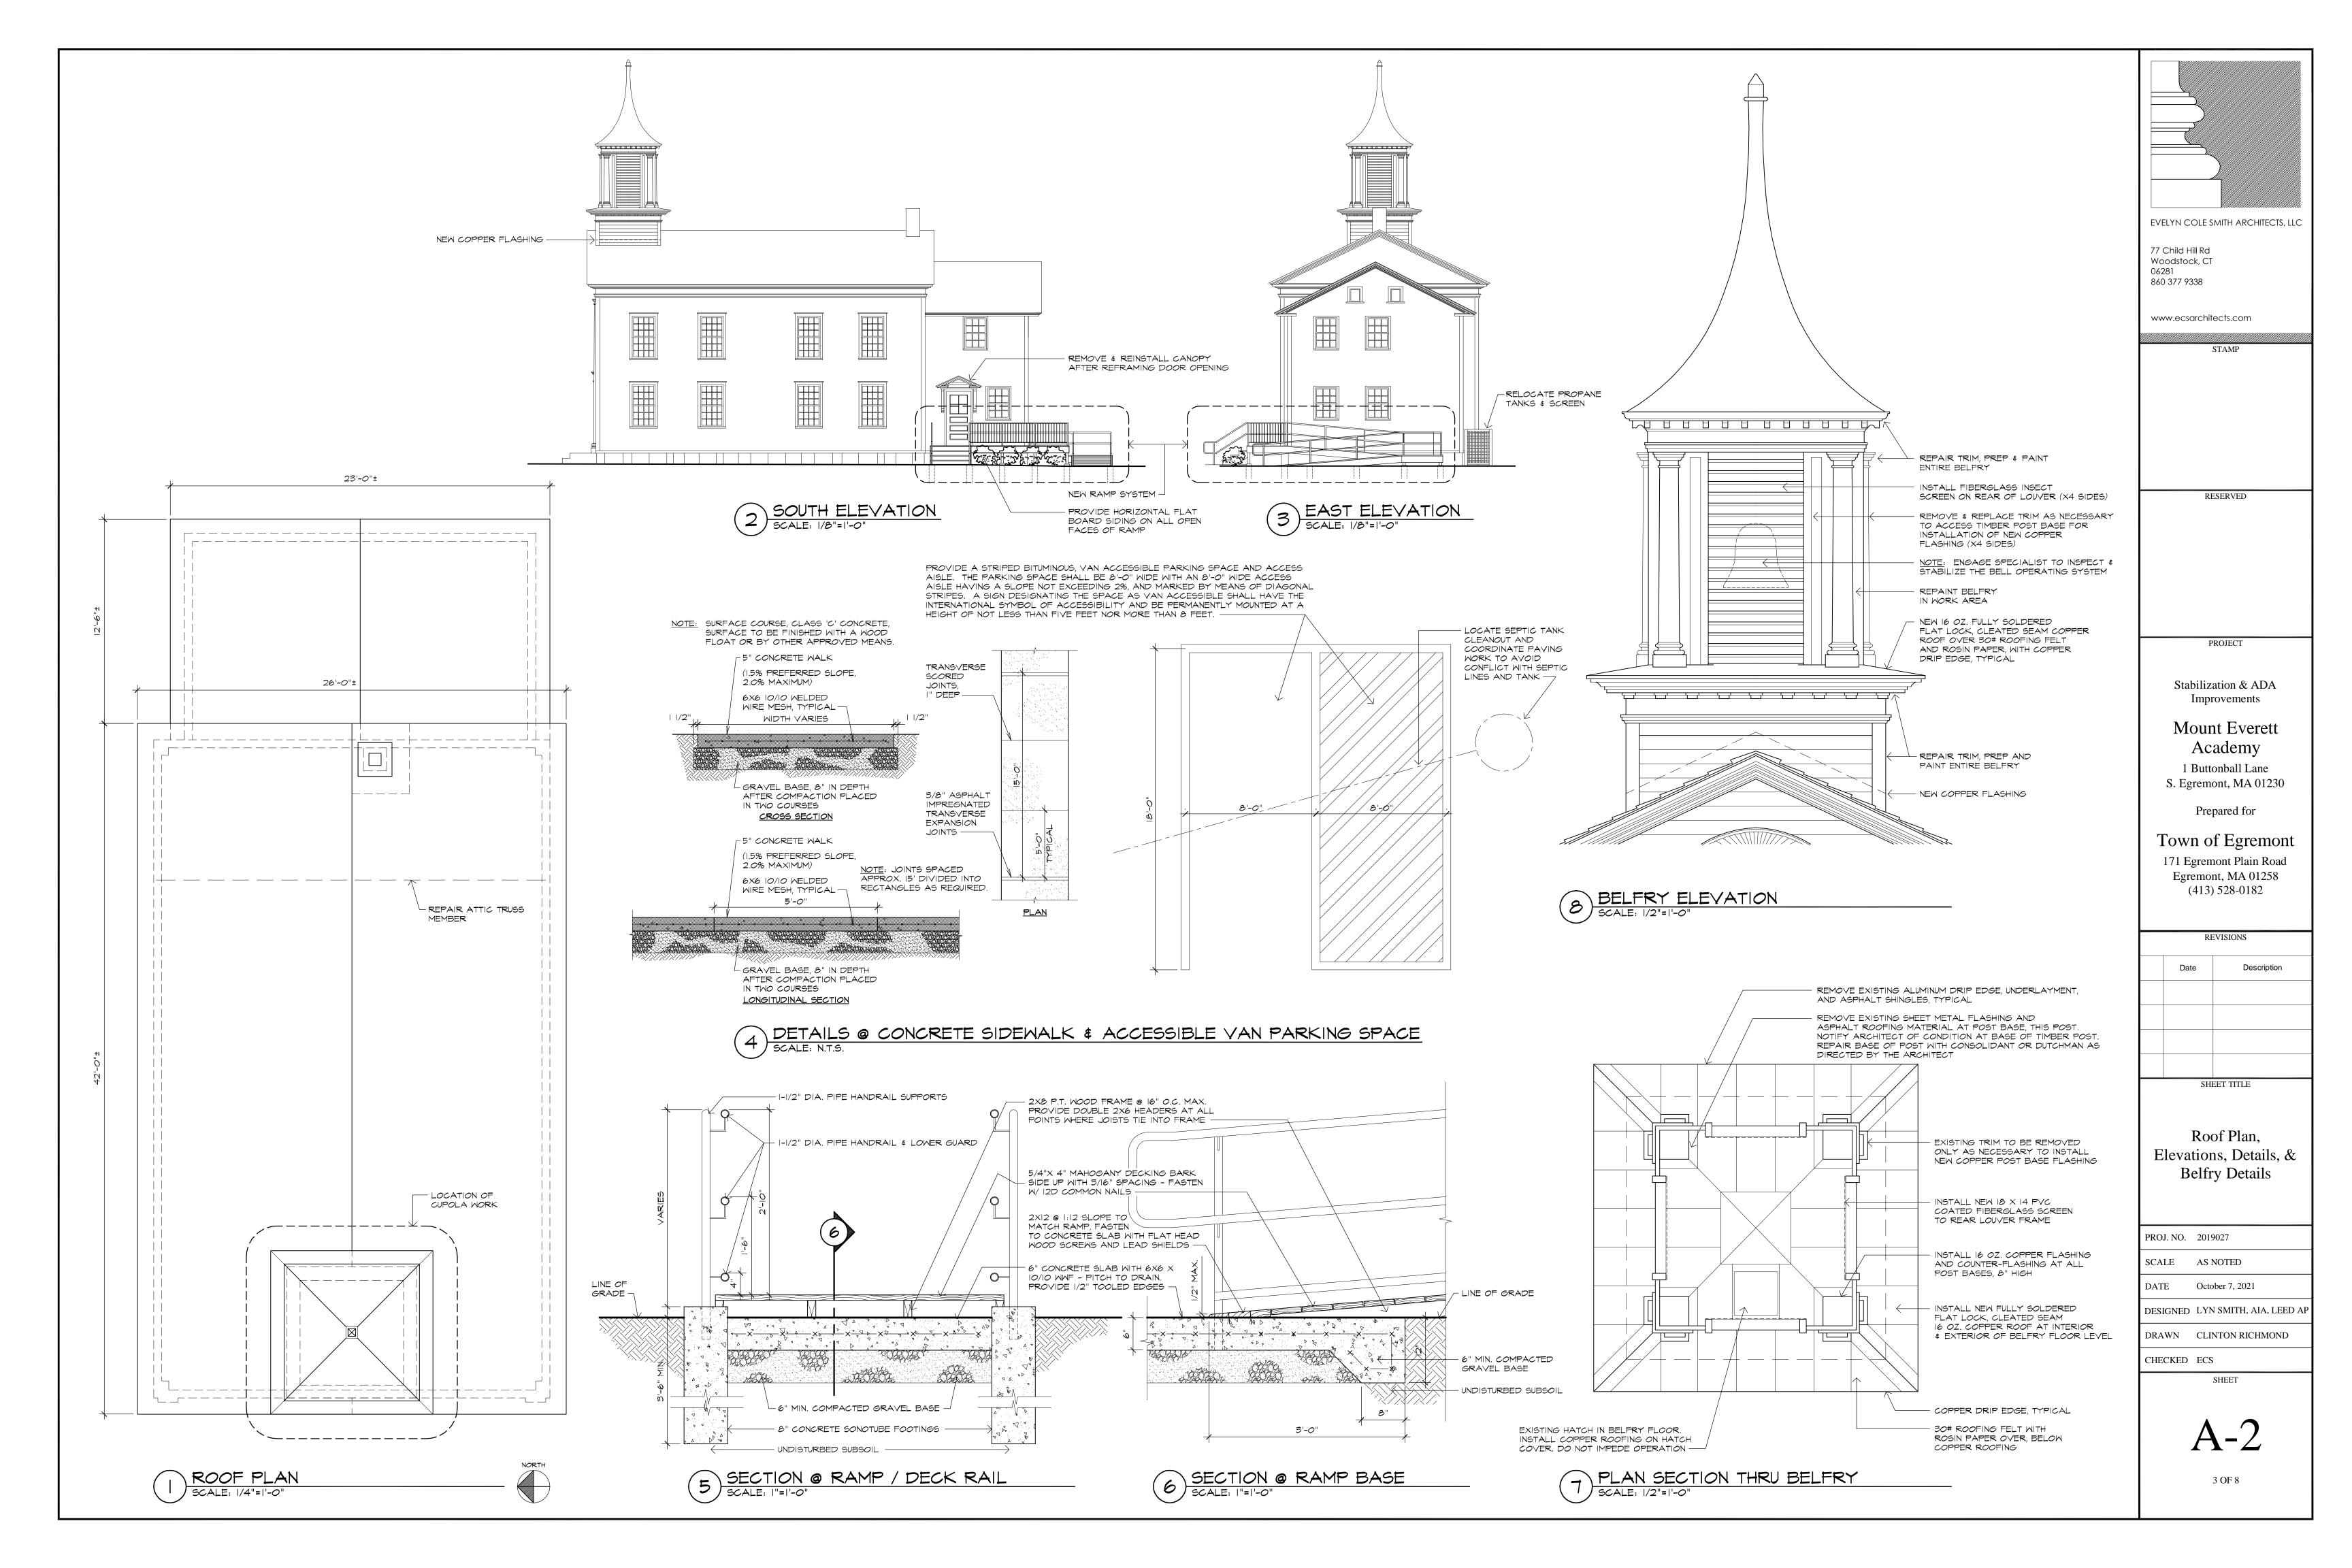			Ro	oom	Finis	sh Sc	hedul	е			
Room Name	Flo	or		W	alls		Cei	ling	Door	Frame	Remarks
ROOM Name	Material	Base	North	East	South	West	Material	Paint	Paint	Paint	Remarks
Unisex Toilet	SV	PVC	P-2	P-2	P-2	P-2	E GWB	P-1	P-3	P-3	Patch exist ceiling
Vestibule	Wood	Wood	P-2	P-2	P-2	P-2	E GWB	P-1	P-3	P-3	Patch exist ceiling
Storage	Wood	Wood	P-2	P-2	P-2	P-2	E GWB	P-1	P-3	P-3	Patch exist ceiling
Janitor's Closet	Conc	NA	P-2	P-2	P-2	P-2	N GWB	P-1	P-3	P-3	New sheetrock clg.
Notes:			•	•	•	•					

P-1: Sherwin Williams, Ceiling white

P-2: Sherwin Williams, acrylic latex, semi-gloss finish, color to be determined.

P-3: Sherwin Williams, acrylic latex, semi-gloss finish, white to match existing trim.

Wood floor to be 3/4" x 4 pine, stained to match adjacent interior stair.

Wood base to be 1 x 4 pine, primed and painted P-3. SV, sheet vinyl floor to be selected from Mannington, Luxury Sheet Vinyl, Platinum Level standard wood look line.

PVC, to be similar to Azek, 1 x 4 base with 3/4" quarter round trim.

Door casings to be 1 x 4 flat stock pine, primed and painted.

DESCRIPTION			SIZE		MA	ΓERI	AL	FRAME	HARDWARE	REMARKS
ROOM NAME	DOOR NUMBER	WIDTH	HEIGHT	THICKNESS	TYPE	WOOD	FOUR PANEL	FRAME MATERIAL	SET NUMBER	
Unisex Toilet Room	1	3'-0"	6'-8''	1 3/8"	Α	•	•	New Wood	1	New opening, paint door and trim.
Storage Closet	2	3'-0"	6'-8"	1 3/8"	А	•	•	New Wood	2	New opening, paint door and trim.
Entrance Door	3	3'-0"	6'-8"	1 3/4"	Exist	•		Modified, Wood	3	Enlarge existing opening, paint door and trim.
Janitor's Closet	4	2'-0"	5'-0''	1 3/8"	Α	•	•	New Wood	2	Create new opening, paint door and trim.
 Door Type A to ho Prime and Paint w 									paint finish.	

1 1/2 Pair butt hinges


Lever handle lockset

Kickdown door holder

1 1/2 Pair spring hinges Lever handle privacy set

Kickdown door holder

Kickplate

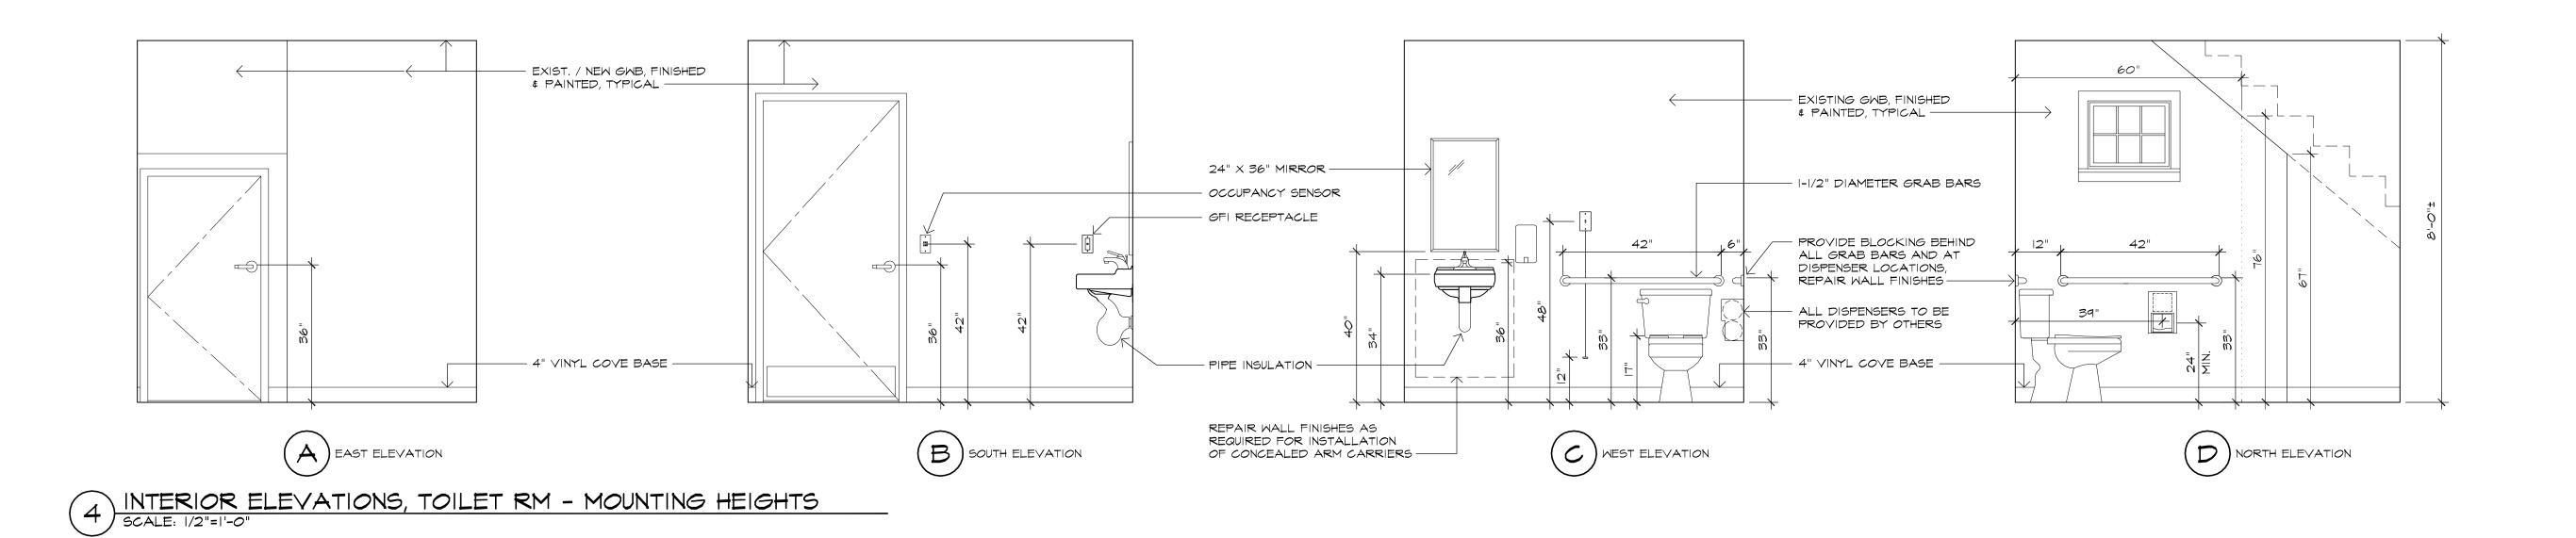


1 1/2 Pair butt hinges


Lever handle lockset

Weatherstripping

ADA compliant closer

ADA Aluminum Threshold

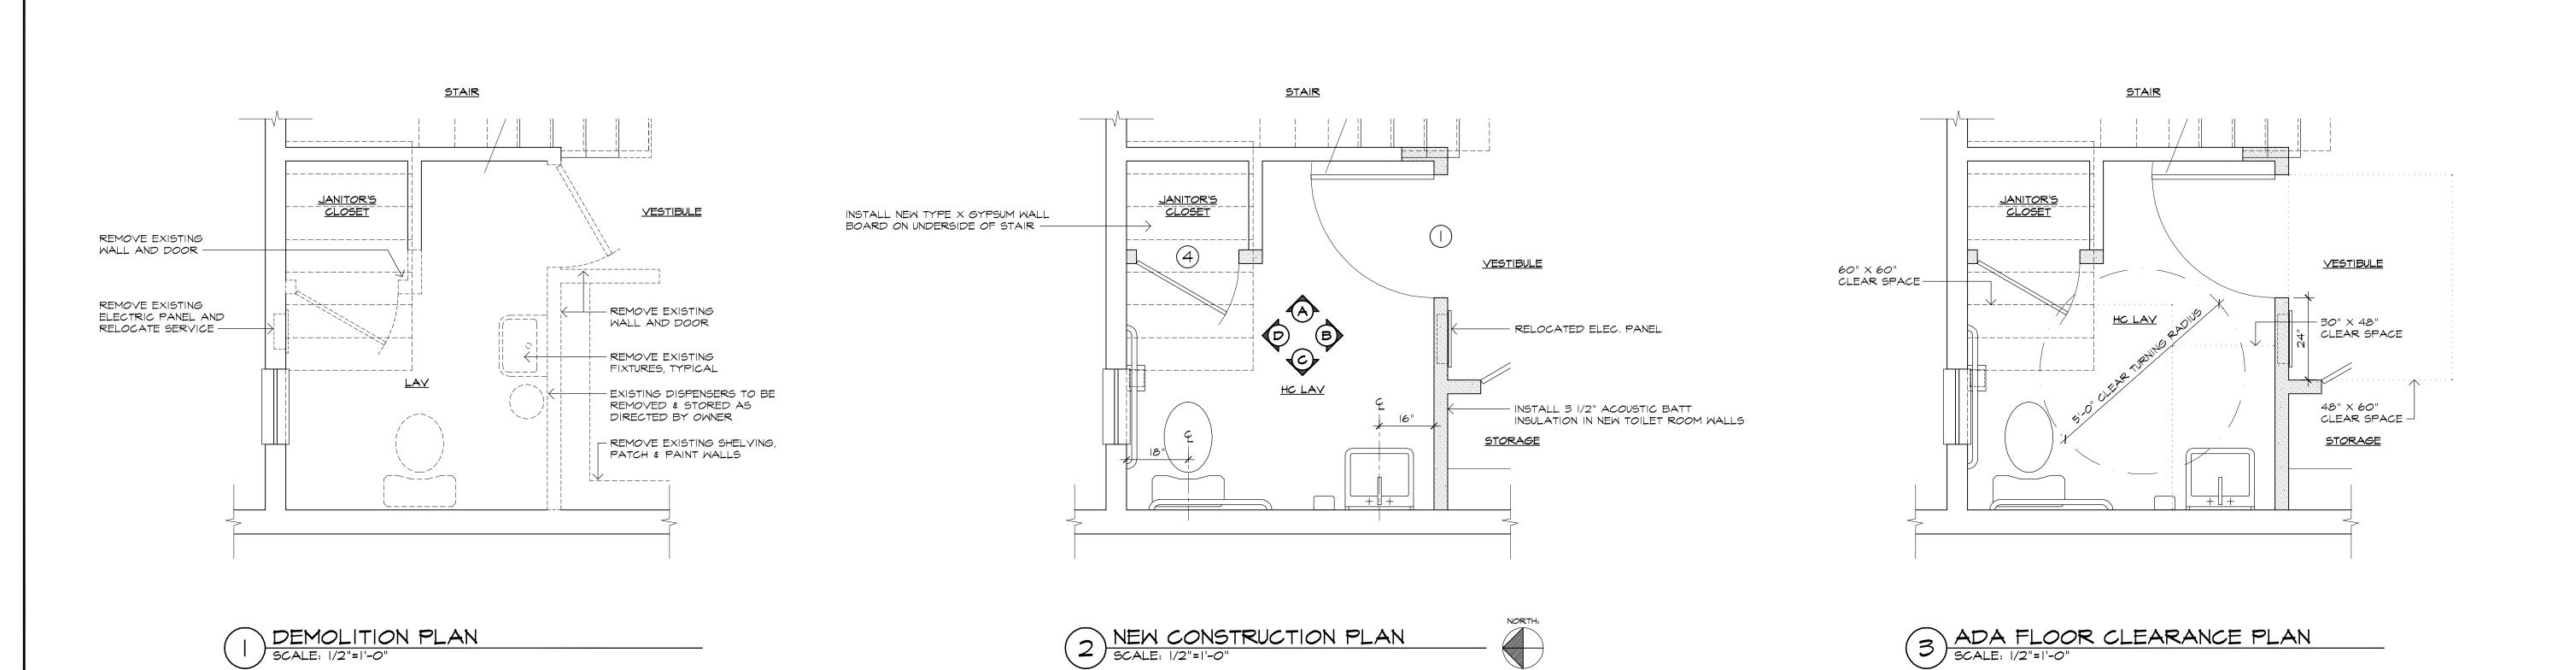

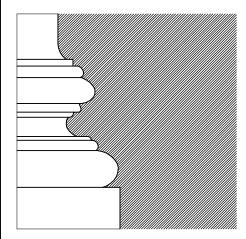

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Stabilization & ADA Improvements

Mount Everett Academy 1 Buttonball Lane

Prepared for

S. Egremont, MA 01230

Town of Egremont 171 Egremont Plain Road Egremont, MA 01258

(413) 528-0182

REVISIONS

	Date	Description
	SHI	EET TITLE

Toilet Room Enlarged Plan & Interior Elevations, & Schedules


PROJ. NO. 2019027 SCALE AS NOTED DATE October 7, 2021

DESIGNED LYN SMITH, AIA, LEED AP

DRAWN CLINTON RICHMOND

CHECKED ECS

4 OF 8

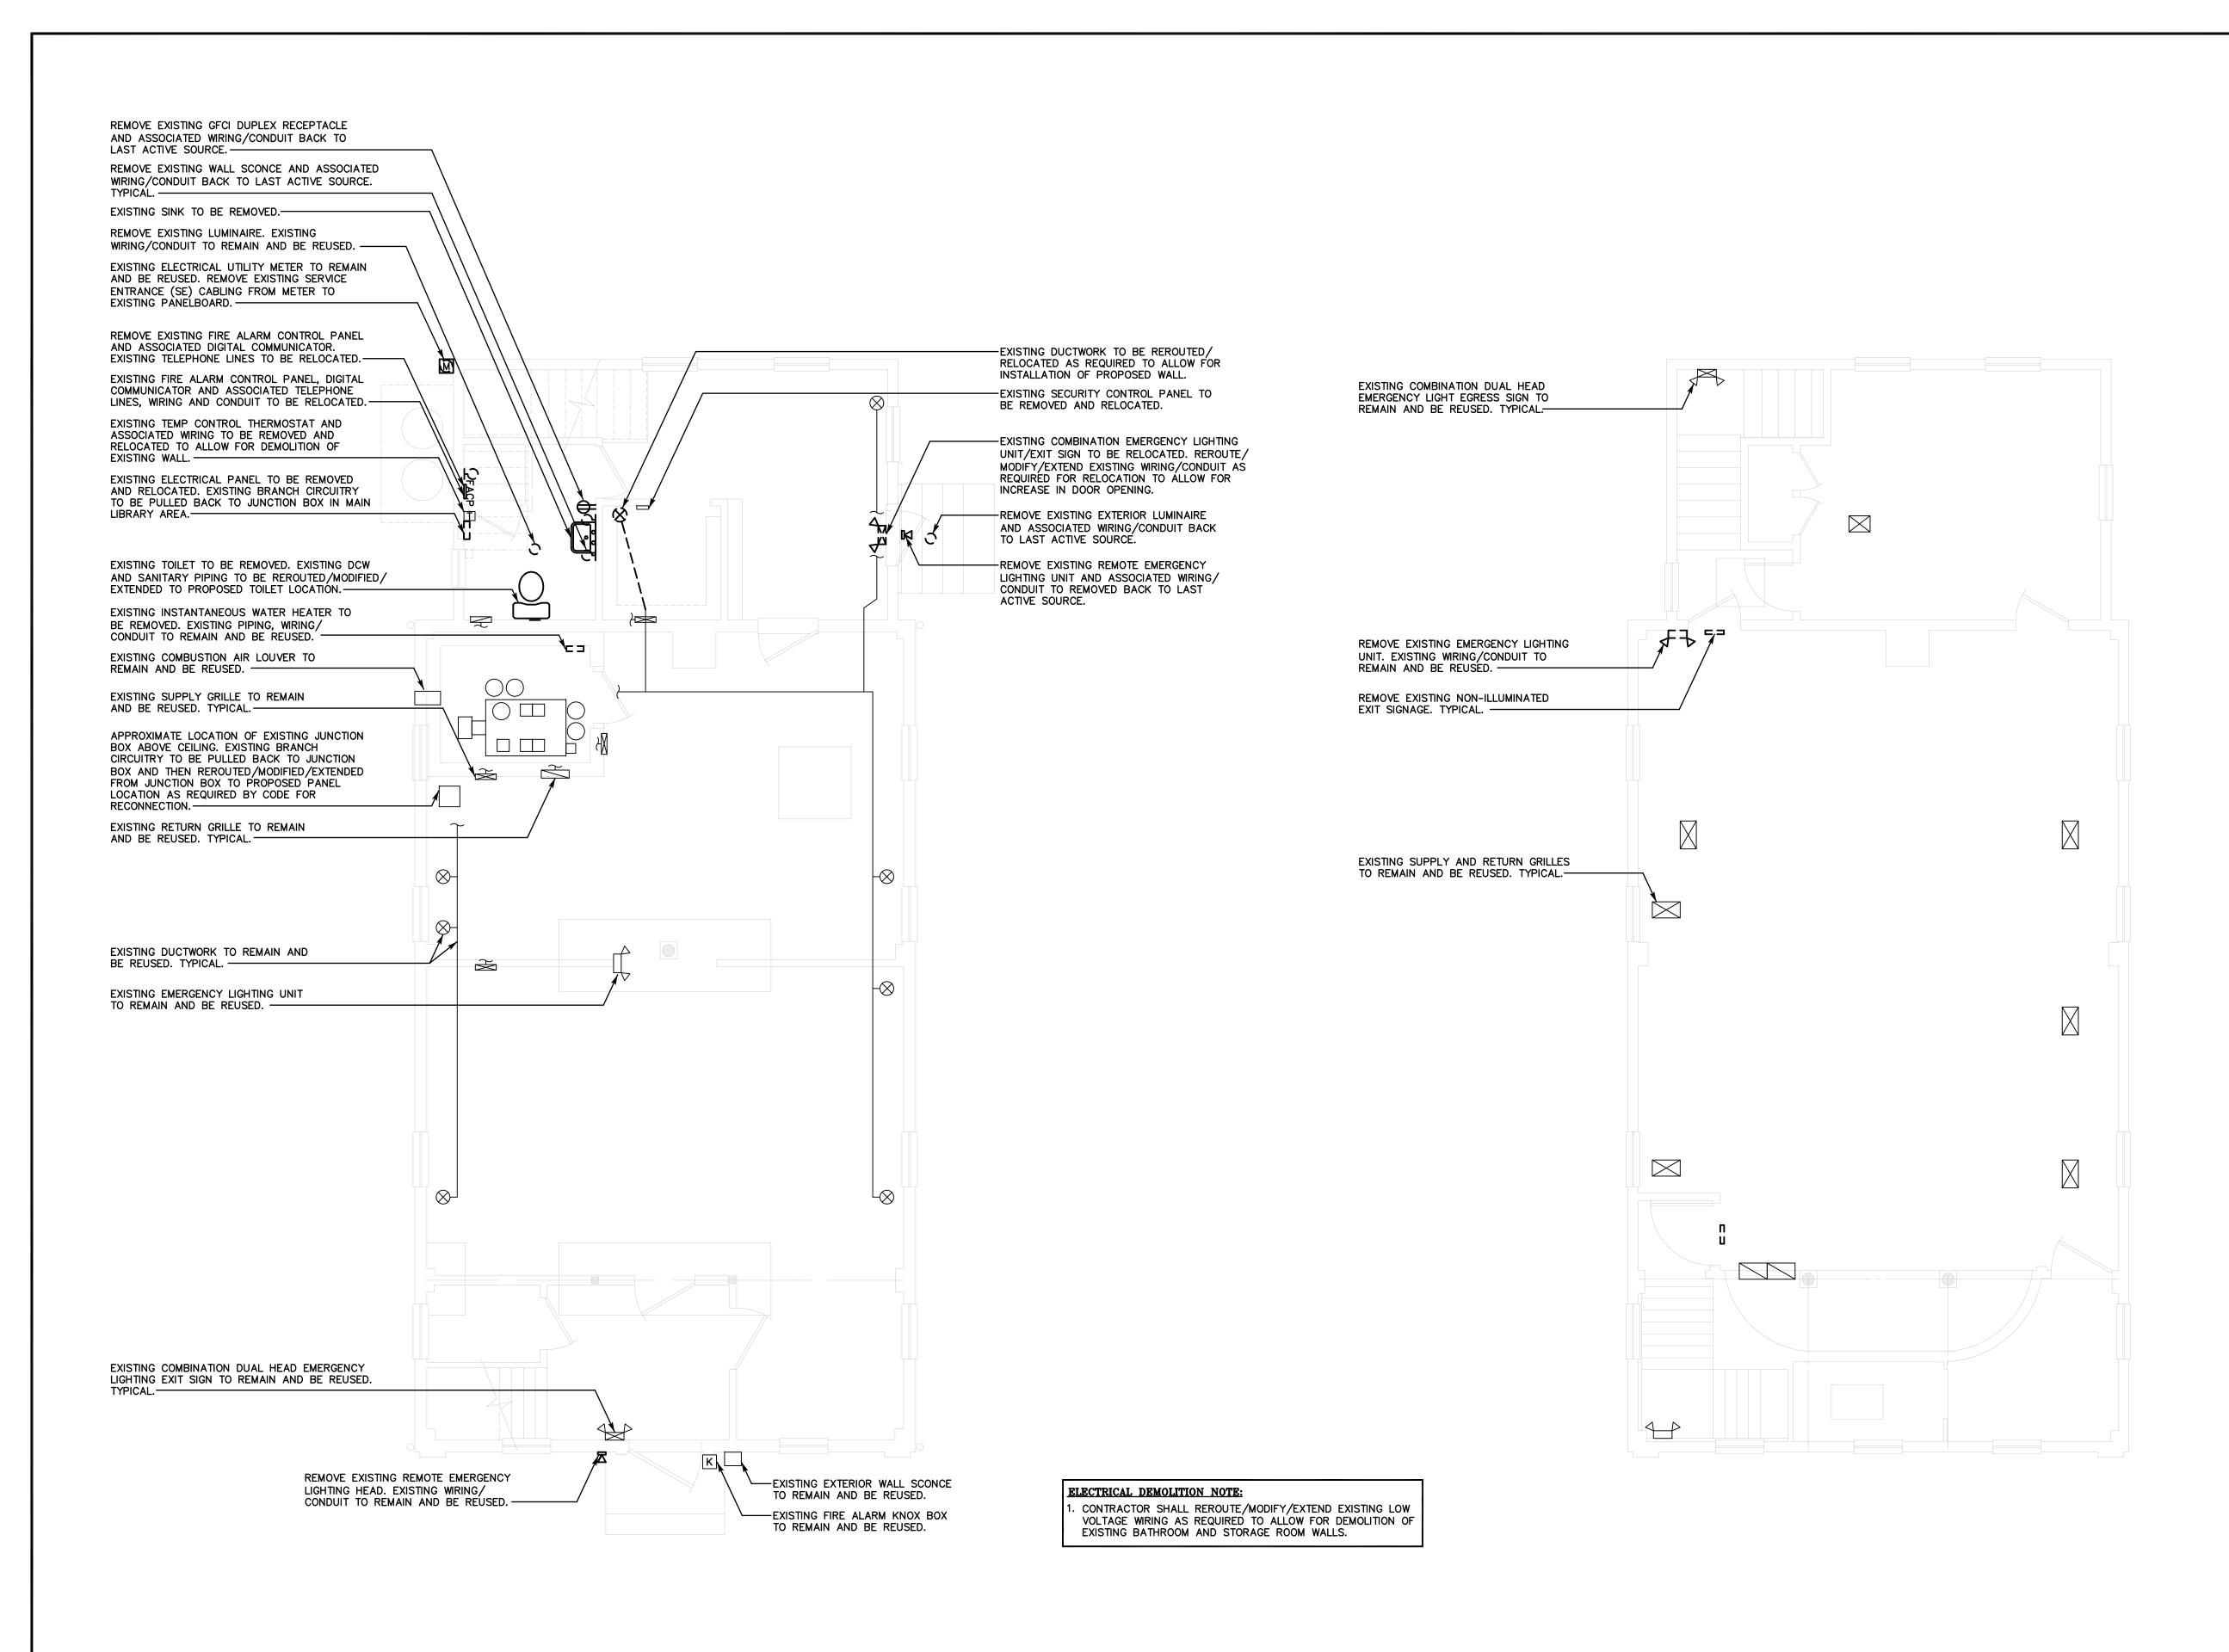

FIRST FLOOR PLUMBING/MECHANICAL/ELECTRICAL

DEMOLITION PLAN

SCALE: 1/4"=1'-0"

SECOND FLOOR PLUMBING/MECHANICAL/ELECTRICAL

DEMOLITION PLAN

SCALE: 1/4"=1'-0"

REVISIONS		
REV.	DESCRIPTION	DATI

CONSULTANT:

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PROJECT TITI

CONTRACT DOCUMENTS



SOUTH EGREMONT, MASSACHUSETTS

DRAWING TITLE


PLUMBING/MECHANICAL/ ELECTRICAL DEMOLITION PLANS

JOB NO.	941 3694.01
PROJECT MANAGER	JAS
ENGINEER/DESIGNER	FB
DRAWN BY	BG
SCALE	AS NOTED
DATE	OCTOBER 7, 2021
CAD FILE: EGREMONT	ACADEMY DPME-1

SEAL:

DRAWING NO.

DPME-1

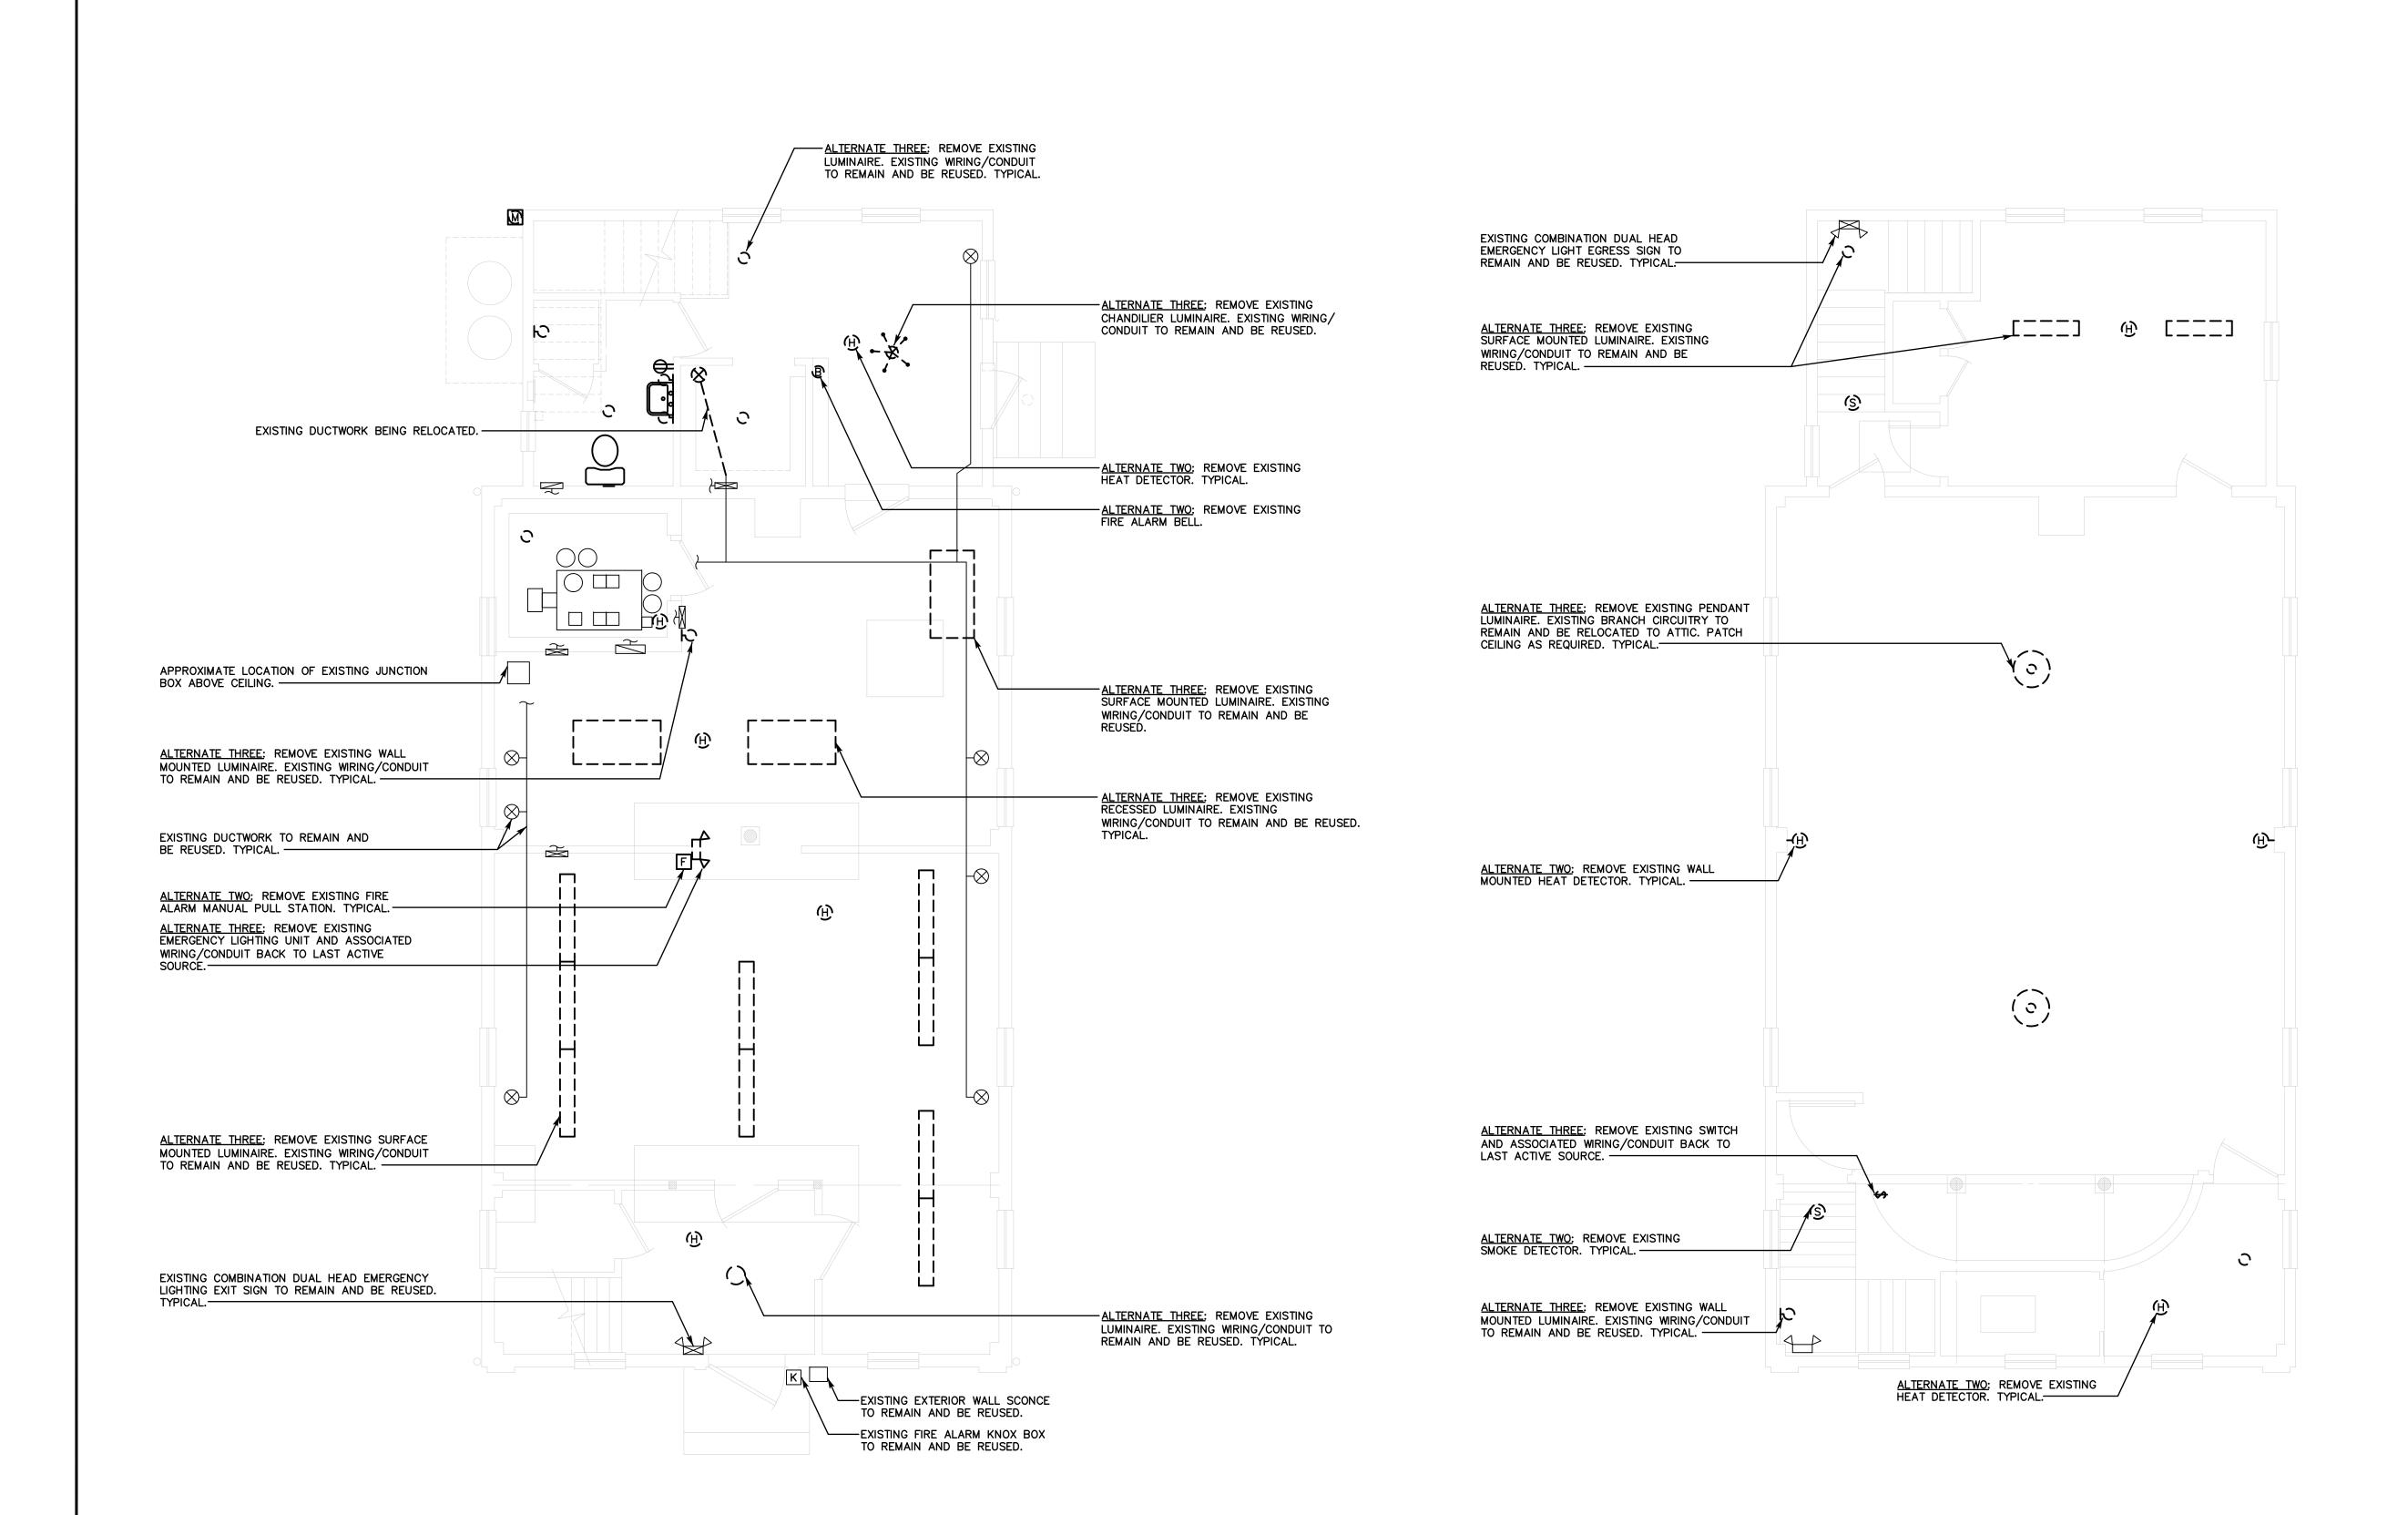

FIRST FLOOR ELECTRICAL

DEMOLITION ALTERNATE PLAN

SCALE: 1/4"=1'-0"

SECOND FLOOR ELECTRICAL

DEMOLITION ALTERNATE PLAN

SCALE: 1/4"=1'-0"

REVISIONS		
REV.	DESCRIPTION	DATE

CONSULTANT:

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PROJECT TITLE

CONTRACT DOCUMENTS FOR

MOUNT EVERETT ACADEMY ADA AND CODE COMPLIANCE

SOUTH EGREMONT, MASSACHUSETTS

DRAWING TITLE


FIRST & SECOND FLOOR ELECTRICAL DEMOLITION ALTERNATE PLANS

JOB NO.	941 3694.01
PROJECT MANAGER	JAS
ENGINEER/DESIGNER	FB
DRAWN BY	BG
SCALE	AS NOTED
DATE	OCTOBER 7, 2021
CAD FILE: EGREMONT	ACADEMY DE-1 ALT

SEAL:			
SEAL.			
	•	•	

DRAWING NO.

DE-1 ALT

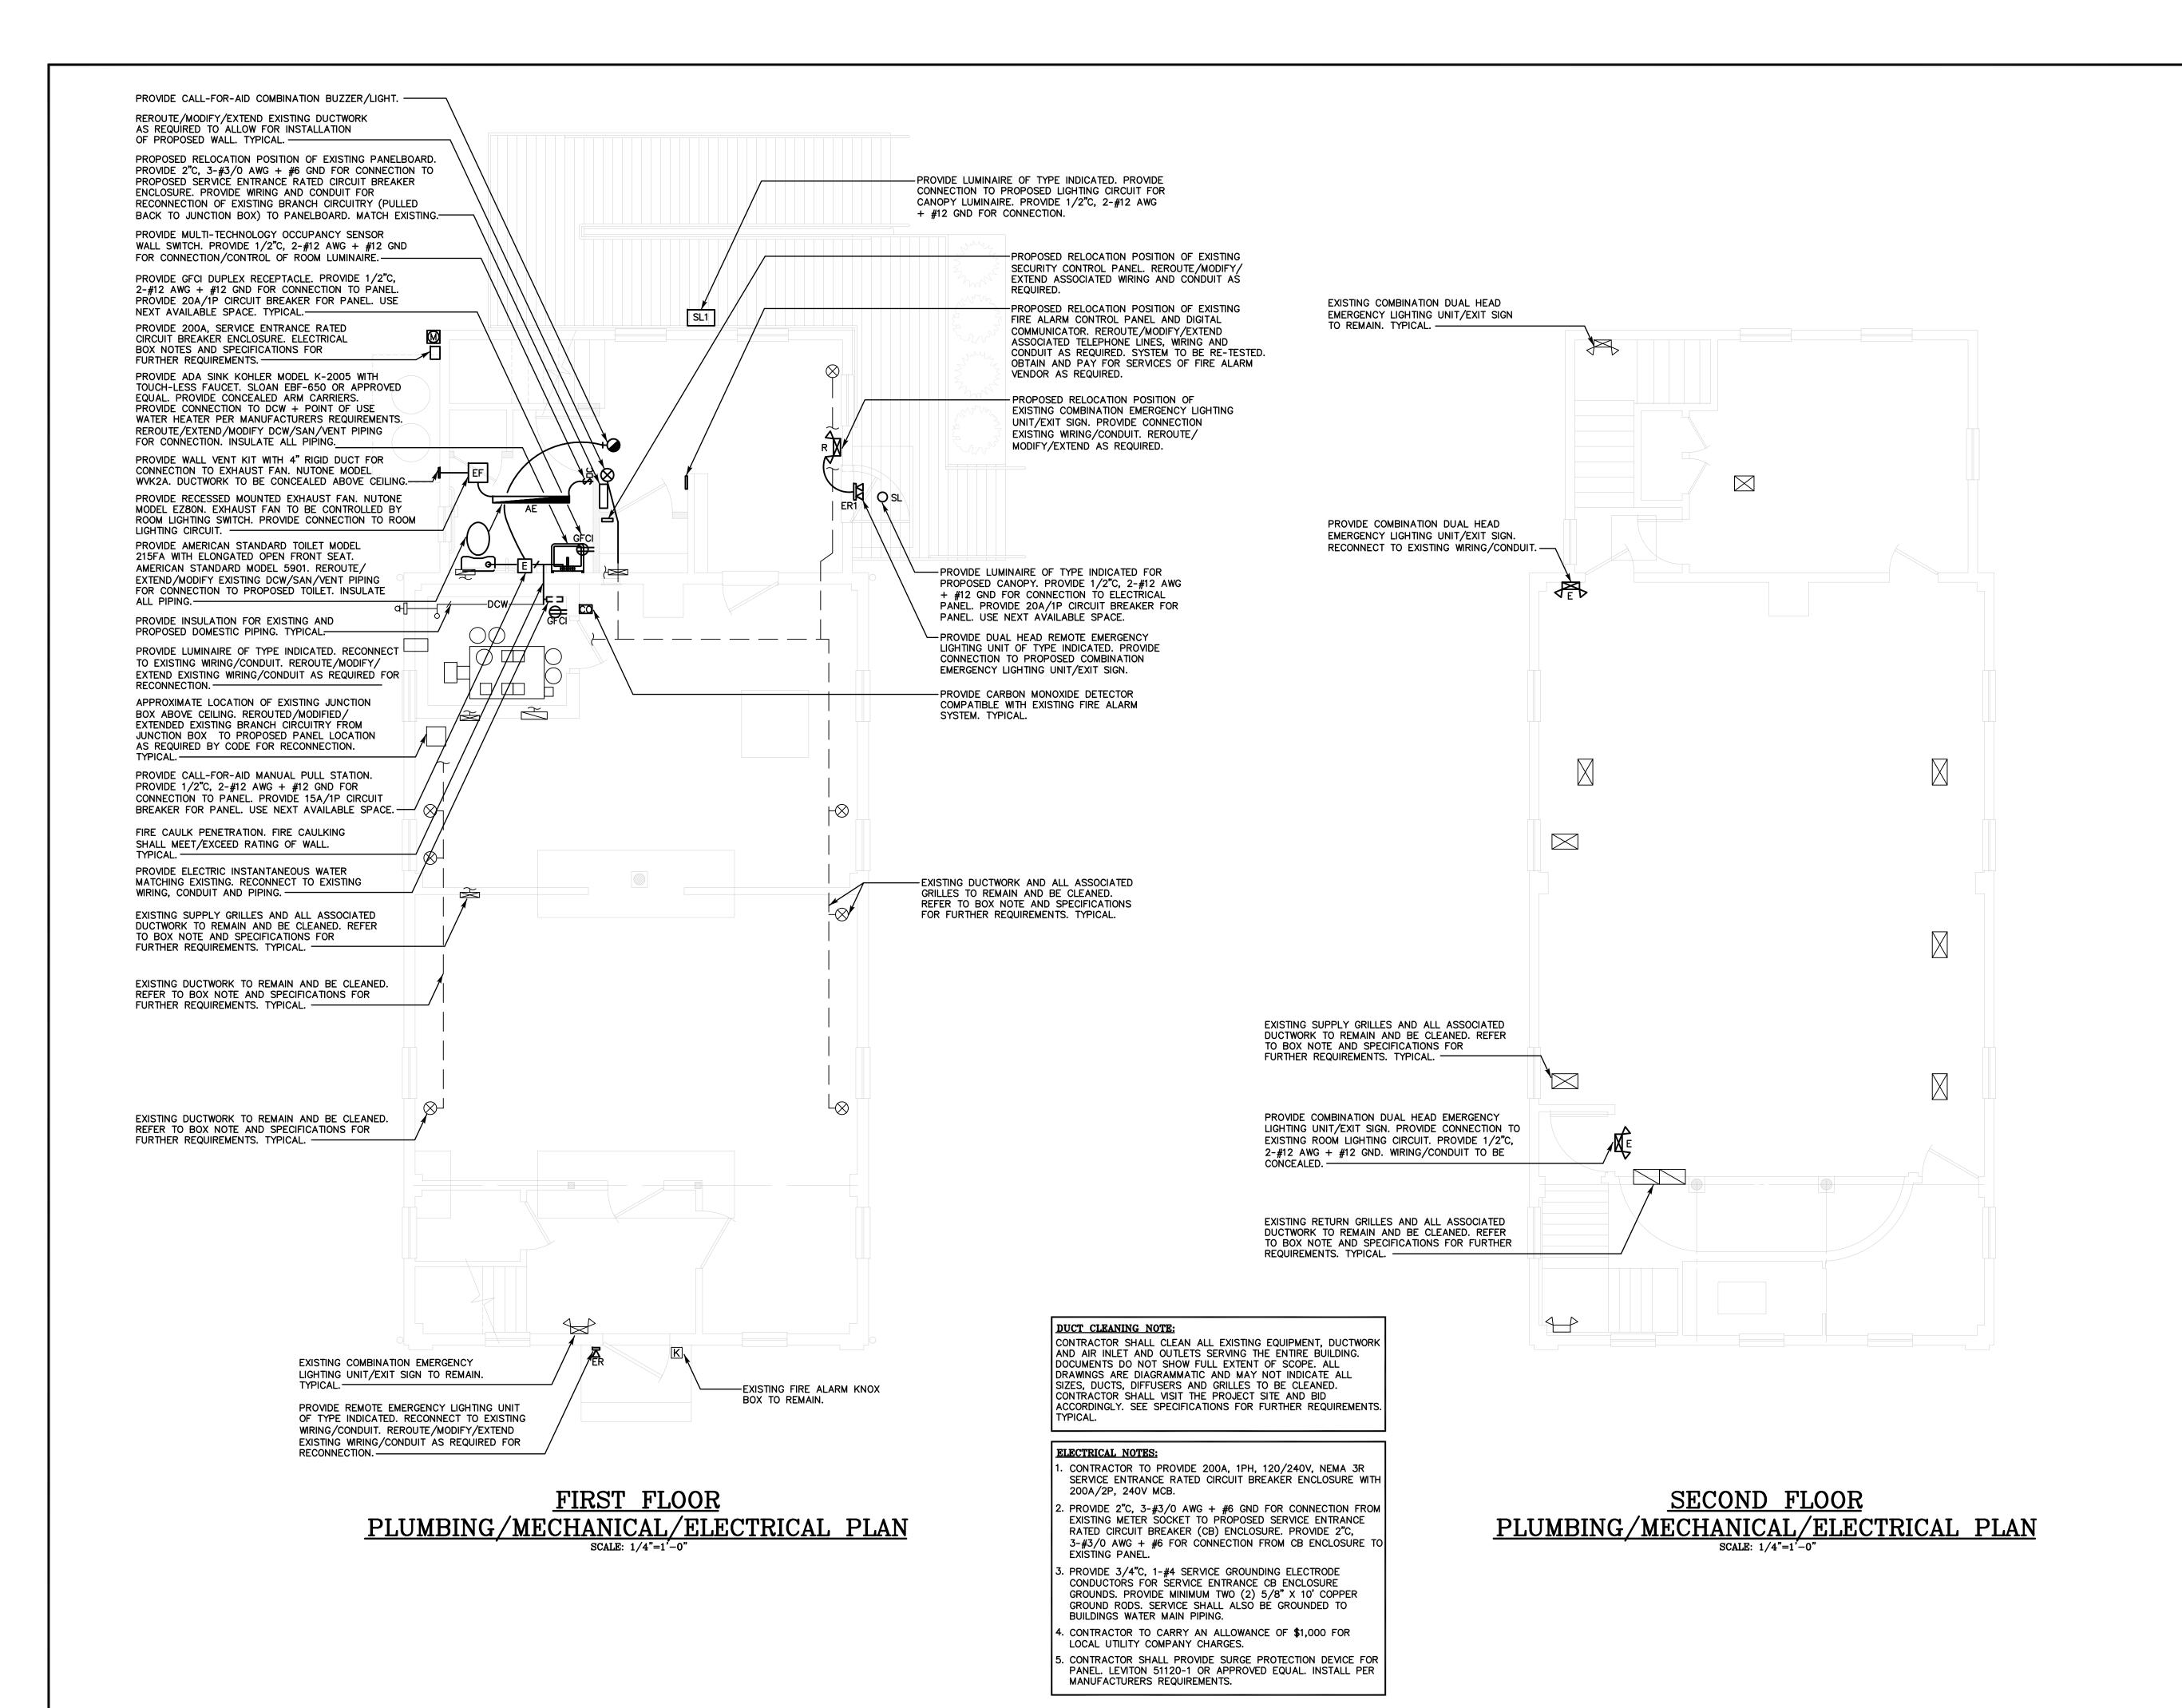

REVISIONS

REV. DESCRIPTION DATE

CONSULTANT:

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PROJECT TITLE

CONTRACT DOCUMENTS FOR

MOUNT EVERETT ACADEMY ADA AND CODE COMPLIANCE

SOUTH EGREMONT, MASSACHUSETTS

DRAWING TITLE


PLUMBING/MECHANICAL/ ELECTRICAL PLANS

JOB NO.	941 3694.01
PROJECT MANAGER	JAS
ENGINEER/DESIGNER	FB
DRAWN BY	BG
SCALE	AS NOTED
DATE	OCTOBER 7, 2021
CAD FILE: EGREMONT	ACADEMY PME-1

SEAL:

DRAWING NO.

PME-1

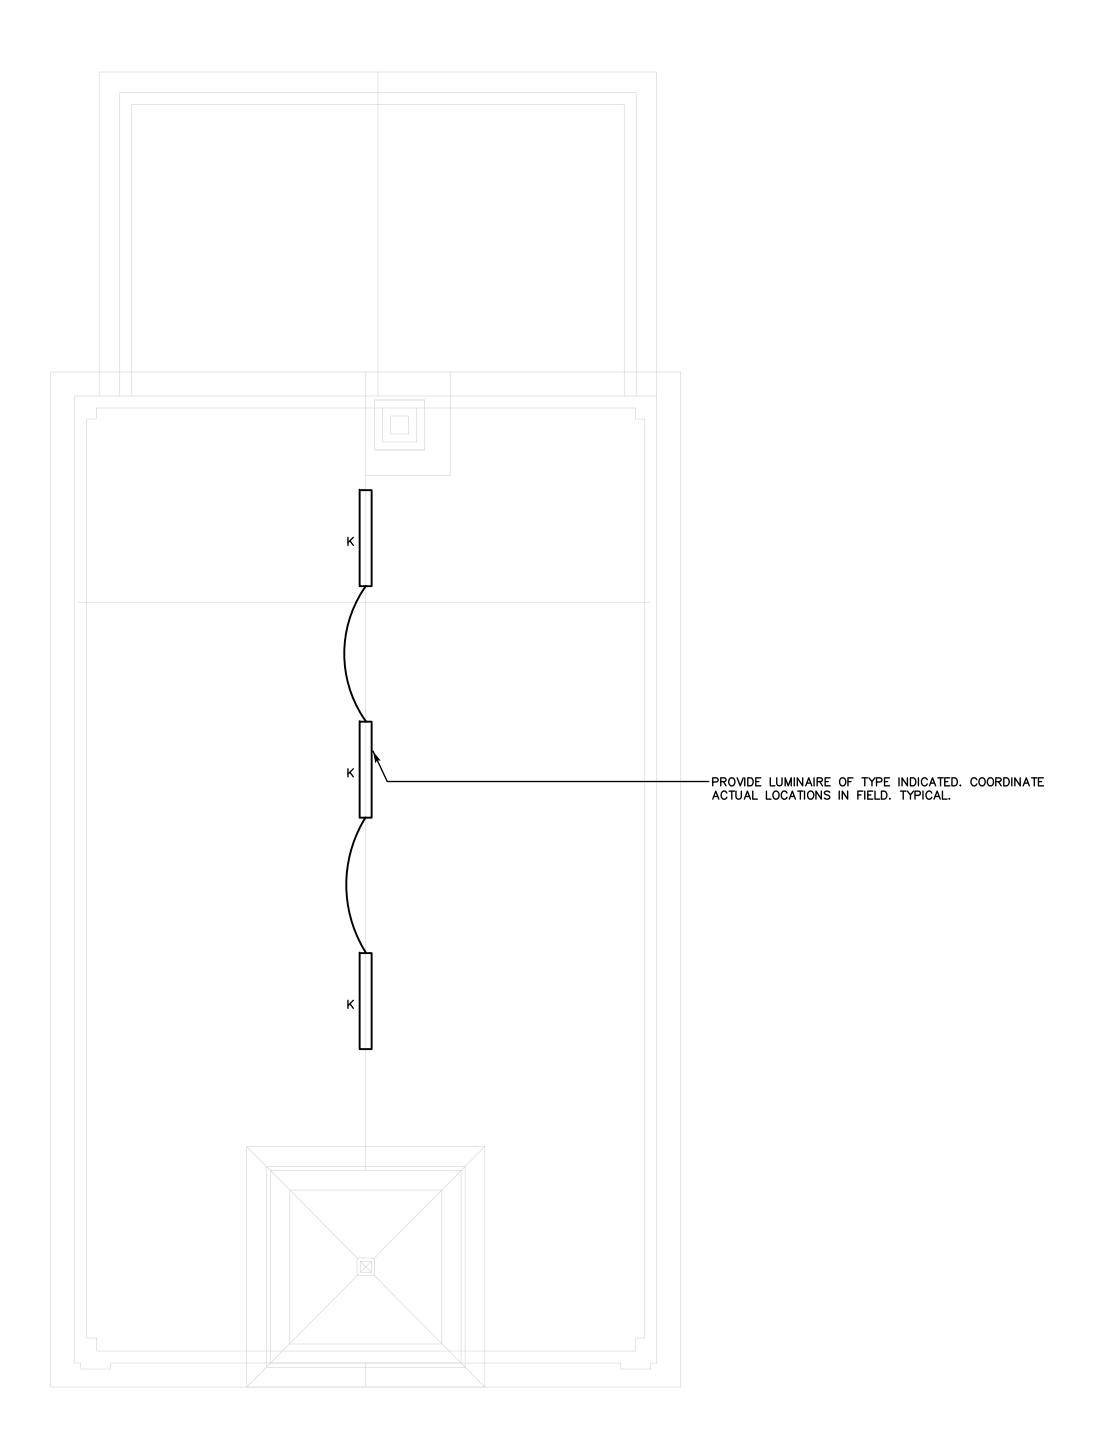

ATTIC
PLUMBING/MECHANICAL/ELECTRICAL PLAN
SCALE: 1/4"=1'-0"

ATTIC LIGHTING NOTE:

CONTRACTOR SHALL PROVIDE LIGHT SWITCH AT EACH ATTIC ENTRY POINT. PROVIDE 1/2"C, 2-#12 AWG + #12 GND FOR CONNECTION TO PANEL. PROVIDE 20A/1P, 240V CIRCUIT BREAKER FOR PANEL. USE NEXT AVAILABLE SPACE.

REVISIONS		
REV.	DESCRIPTION	DATI

CONSULTANT:

SALAMONE & ASSOCIATES, P.C.

CONSULTING ENGINEERS

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PROJECT TITLE

CONTRACT DOCUMENTS FOR



SOUTH EGREMONT, MASSACHUSETTS

DRAWING TITLE

PLUMBING/MECHANICAL/ ELECTRICAL ATTIC PLAN

941 3694.01
JAS
FB
BG
AS NOTED
OCTOBER 7, 2021
CADEMY PME-2

SEAL:

DRAWING NO.

PME-2

	LUMINAIRE SO	CHED	ULE		
LTG. CODE	DESCRIPTIONS	VOLTS	CATALOG NO./ MANUFACTURER	MOUNTING	LAMPING
'A'	4'X4" WRAPAROUND LED. 4000 NOMINAL LUMEN OUTPUT. 3500K COLOR TEMP. FROSTED ACRYLIC DIFFUSER. DIMMING DRIVER. WIRELESS CONNECTIVITY SYSTEM WITH INTEGRAL DAYLIGHT & OCCUPANCY SENSORS. WHITE FINISH. COMMISSIONING REMOTE. FIVE YEAR WARRANTY. UL LISTED.	UNV	FSW440L835-UNV-DIM-SWZCS SIGNIFY DAYBRITE	SURFACE/ CEILING	LED
'AE'	FIXTURE TYPE A WITH INTEGRAL 90 MINUTE EMERGENCY BATTERY PACK AND TEST SWITCH.	UNV	FSW440L835-UNV-DIM-EMLED -SWZCS SIGNIFY DAYBRITE	SURFACE/ CEILING	LED
'B'	2'X4' RECESSED LED. 4800 NOMINAL LUMEN OUTPUT. 3500K COLOR TEMP. FLAT SMOOTH DIFFUSER. DIMMING DRIVER. WIRELESS CONNECTIVITY SYSTEM WITH INTEGRAL DAYLIGHT & OCCUPANCY SENSORS. WHITE FINISH. COMMISSIONING REMOTE. FIVE YEAR WARRANTY. UL LISTED.	UNV	2FGXG48L835-4-FS-UNV-DIM -SWZCS SIGNIFY DAYBRITE	RECESSED/ CEILING	LED
BE'	FIXTURE TYPE B WITH INTEGRAL 90 MINUTE EMERGENCY BATTERY PACK AND TEST SWITCH.	UNV	2FGXG48L835-4-FS-UNV-DIM -BSL10LST-SWZCS SIGNIFY DAYBRITE	RECESSED/ CEILING	LED
c'	1'X4' SURFACE MOUNTED LED. 4500 NOMINAL LUMEN OUTPUT. 3500K COLOR TEMP. FLAT SMOOTH DIFFUSER. DIMMING DRIVER. WIRELESS CONNECTIVITY SYSTEM WITH INTEGRAL DAYLIGHT & OCCUPANCY SENSORS. WHITE FINISH. SURFACE MOUNT KIT. COMMISSIONING REMOTE. FIVE YEAR WARRANTY. UL LISTED.	UNV	1FGXG45L835-4-FS-UNV-DIM -SWZCS-FSK14. SIGNIFY DAYBRITE	SURFACE/ CEILING	LED
D'	SWING ARM WALL SCONCE WITH SHADE. 12W LED E26/MEDIUM LIGHT SOURCE. METAL HOUSING. FINISH BY ARCHITECT/OWNER. UL LISTED.	120	13940XX ASTRO LIGHTING	SURFACE/ WALL	LED
E'	COMBINATION DUAL HEAD EMERGENCY LIGHTING UNIT AND EXIT SIGN. LED, FULLY ADJUSTABLE HEADS, RED LETTERING, WHITE THERMOPLASTIC HOUSING, 90 MINUTE BATTERY BACK-UP. SELF-TESTING, SELF-DIAGNOSTICS. UL LISTED.	120	CLCNRW SIGNIFY CHLORIDE	UNIVERSAL	LED
ER'	SINGLE HEAD (1.5W) LED REMOTE EXTERIOR EMERGENCY LIGHTING. FULLY ADJUSTABLE HEAD. THERMOPLASTIC HOUSING. MULTI-VOLTAGE4°F TO 122° OPERATING TEMPERATURE. WHITE FINISH. UL LISTED WET LOCATIONS.	UNV	MLED1-W-WP BARRON LIGHTING	SURFACE/ WALL	LED
'ER1'	DUAL HEAD (1.5W EACH) LED REMOTE EXTERIOR EMERGENCY LIGHTING. FULLY ADJUSTABLE HEAD. THERMOPLASTIC HOUSING. MULTI-VOLTAGE4°F TO 122° OPERATING TEMPERATURE. WHITE FINISH. UL LISTED WET LOCATIONS.	UNV	MLED2-W-WP BARRON LIGHTING	SURFACE/ WALL	LED
F'	20" ROUND, 27.75" HIGH LED FIXTURE. 31W, 3200 NOMINAL LUMEN OUTPUT. 3500K COLOR TEMP. WHITE ALABASTER GLASS LENS. 0-10V DIMMABLE DRIVER. OLD BRONZE FINISH. UL LISTED.	UNV	TGAPD-W31-DVD-35K-D20 ASL LIGHTING	SUSPEND/ CEILING	LED
'G'	11" ROUND SURFACE MOUNTED LED. 2.3" DEPTH. 1050 NOMINAL LUMEN OUTPUT. 3000K COLOR TEMP. HIGH TRANSMISSION FROSTED GLASS SHADE. SATIN NICKEL FINISH. HIGH POWER FACTOR, LOW THD. FIVE YEAR WARRANTY. UL LISTED.	UNV	1912D-62-3000K SUNPARK ELECTRONICS	SURFACE/ CEILING	LED
H'	15" ROUND, 15" HIGH LED FIXTURE. 20W, 1995 NOMINAL LUMEN OUTPUT. 3500K COLOR TEMP. WHITE ALABASTER GLASS LENS. DIMMABLE DRIVER. OLD BRONZE FINISH. UL LISTED.	UNV	TGAP-W20-TD-35K-D15 ASL LIGHTING	SUSPEND/ CEILING	LED
'I '	7" ROUND SLIM SURFACE MOUNTED LED. 5/8" DEPTH. 1000 NOMINAL LUMEN OUTPUT. 3500K COLOR TEMP. SMOOTH HIGH TRANSMITTANCE LENS. WHITE FINISH. FIVE YEAR WARRANTY. UL LISTED.	UNV	S7R83510 SIGNIFY LIGHTOLIER	SURFACE/ CEILING	LED
J'	13" WIDE, HALF MOON LED WALL SCONCE. 15W, 1400 NOMINAL LUMEN OUTPUT. 3500K COLOR TEMP. WHITE ACRYLIC LENS. FINISH BY ARCHITECT. FIVE YEAR WARRANTY. UL LISTED.	120	WQR-W15-TD-35K-W13 ASL LIGHTING	SURFACE/ WALL	LED
κ'	4'X4" WRAPAROUND LED. 4000 NOMINAL LUMEN OUTPUT. 3500K COLOR TEMP. FROSTED ACRYLIC DIFFUSER. DIMMING DRIVER. WHITE FINISH. FIVE YEAR WARRANTY. UL LISTED.	UNV	FSWEZ440L835-UNV SIGNIFY DAYBRITE	SURFACE/ CEILING	LED
'SL'	3.5" ROUND, 5.75" HIGH EXTERIOR CANOPY FIXTURE. 19W, 1400 NOMINAL LUMEN OUTPUT. 3500K COLOR TEMP. CLEAR LENS. DIMMABLE DRIVER. OIL RUBBED BRONZE FINISH. UL DAMP LOCATION LISTED.	UNV	CTCA-W19-DVD-35K-ORB ASL LIGHTING	SURFACE/ CANOPY	LED
'SL1'	17" EXTERIOR LED WALL SCONCE WITH MOTION SENSOR LENS. 2885 NOMINAL LUMEN OUTPUT. 3000K COLOR TEMP. TYPE III DISTRIBUTION. PHOTOCELL CONTROL BUTTON. COLD WEATHER EMERGENCY BATTERY PACK. BRONZE FINISH. UL WET	120	121-16L-530-WW-G4-3-EBPC- 120-IMRI2-PCB-BZ SIGNIFY GARDCO	SURFACE/ WALL	LED

— THE HANDICAPPED CALL-FOR-AID LIGHT/BUZZER WITHIN SINGLE GANG 1/2"C, 2-#12 AWG + EDWARDS SIGNALING MODEL '7641-1N5', STAINLESS WITH WHITE DOME. 1/2"C, 2-#12 AWG + #12 GND -EMERGENCY CALL-FOR-AID SWITCH. MOUNT SWITCH 48" A.F.F. WITH PULL CORD HANDING DOWN TO 6" A.F.F. EDWARDS SIGNALING MODEL '6537' WITH STAINLESS STEEL PLATE.

ELECTRICAL GENERAL NOTES

- . SEE SPECIFICATIONS, DIVISION 16 ELECTRICAL.
- 2. PROVIDE A COMPLETE AND OPERATIONAL ELECTRICAL SYSTEM INCLUDING ALL NECESSARY MATERIAL, LABOR AND EQUIPMENT.
- 3. ELECTRICAL PLANS AND DETAILS AND ONE LINE DIAGRAMS SHOW THE GENERAL LOCATION AND ARRANGEMENT OF THE ELECTRICAL SYSTEM. THEY ARE DIAGRAMMATIC AND DO NOT SHOW ALL CONDUIT BODIES, CONNECTORS, BENDS, FITTINGS, HANGERS AND ADDITIONAL PULL AND JUNCTION BOXES
- 4. ALL EQUIPMENT AND MATERIAL SHALL BE LABELED, LISTED AND INSTALLED IN ACCORDANCE WITH THEIR LISTING.
- 5. THE CONTRACTOR SHALL OBTAIN ALL REQUIRED PERMITS AND ARRANGE FOR ALL REQUIRED INSPECTIONS IN ACCORDANCE WITH STATE AND LOCAL GOVERNING AUTHORITIES
- 6. ALL WORK SHALL BE DONE WITH LICENSED WORKMEN IN ACCORDANCE WITH
- STATE AND LOCAL GOVERNING AUTHORITIES. 7. THE DEFINITION OF ELECTRICAL TERMS USED SHALL BE AS DEFINED IN THE
- 2020 EDITION OF THE MASSACHUSETTS ELECTRICAL CODE (MEC). 8. THE TERM "INDICATED" SHALL MEAN "AS SHOWN ON CONTRACT DOCUMENTS
- (SPECIFICATIONS, DRAWINGS AND RELATED ATTACHMENTS)". 9. THE TERM "PROVIDE" SHALL MEAN "TO FURNISH, INSTALL AND CONNECT
- 10. THE TERM "SIZE" SHALL MEAN ONE OR MORE OF THE FOLLOWING: "LENGTH,
- SIMILAR ELECTRICAL CHARACTERISTICS". THE TERM "SPACE" ON PANELBOARD AND SWITCHBOARD SCHEDULES SHALL MEAN "PROVIDE SPACE TO INSTALL THE NUMBER OF POLES AND SIZE OF THE PROTECTIVE DEVICE INDICATED WITH ALL NECESSARY BUS AND FITTINGS TO

CURRENT AND VOLTAGE RATING, NUMBER OF POLES, NEMA SIZE AND OTHER

- INSTALL THE DEVICE AT SOME FUTURE DATE". 12. ELECTRICAL PLANS AND DETAILS DO NOT SHOW ALL INTERFERENCES AND CONDITIONS. VISIBLE AND/OR HIDDEN. THAT MAY EXIST: THUS REQUIRING THE CONTRACTOR TO INSPECT AND SURVEY THE SPACE BEFORE PERFORMING THE WORK.
- 13. COORDINATE ELECTRICAL WORK WITH OWNER.
- 14. COORDINATE ELECTRICAL WORK WITH OTHER DIVISIONS OF THIS PROJECT.
- 15. TURN OVER TO THE OWNER ALL MANUFACTURERS WARRANTIES FOR EQUIPMENT AND MATERIAL PROVIDED.
- 16. UNLESS OTHERWISE INDICATED, ALL ELECTRICAL EQUIPMENT HAS BEEN BASED ON GENERAL ELECTRIC PRODUCTS.
- 17. THE CONTRACTOR MAY SUBSTITUTE EQUIPMENT OF ANOTHER MANUFACTURER IF IT IS OF EQUAL QUALITY AND RATING, SUBJECT TO OWNER'S AND ENGINEER'S REVIEW AND ACCEPTANCE.
- 18. UNLESS OTHERWISE INDICATED, ALL ENCLOSURES FOR EQUIPMENT PROVIDED SHALL BE NEMA TYPE 1.
- 19. UNLESS OTHERWISE INDICATED, ALL CONDUCTORS TO BE COPPER THHN/THWN-2
- 20. UNLESS OTHERWISE INDICATED, ALL OUTLET AND SWITCH BOXES TO BE CAST IRON WITH THREADED HUBS.
- 21. IN INTERIOR PROTECTED LOCATIONS, OUTLET AND SWITCH BOXES MAY BE
- 22. UNLESS OTHERWISE INDICATED, PROVIDE HEAVY-DUTY GRADE, 20 AMPERE RECEPTACLES AND SWITCHES. PROVIDE COVER PLATES MATCHING DEVICE TYPE AND COLOR. COVER PLATES FOR SURFACE MOUNTED INTERIOR BOXES IN UNFINISHED AREAS SHALL BE STAMPED STEEL. PLATES EXPOSED TO WEATHER/ WATER TO BE GASKETED, WEATHERPROOF TYPE. REFER TO ARCHITECTURAL FOR DEVICE TYPE AND COLOR.
- 23. BEFORE SELECTING MATERIAL AND EQUIPMENT, AND PROCEEDING WITH WORK, INSPECT AREAS WHERE MATERIAL AND EQUIPMENT ARE TO BE INSTALLED TO INSURE SUITABILITY, AND CHECK NEEDED SPACE FOR PLACEMENT, CLEARANCES AND INTERCONNECTIONS.
- 24. BEFORE CUTTING OR DRILLING INTO BUILDING ELEMENTS, INSPECT AND LAYOUT WORK TO AVOID DAMAGING STRUCTURAL ELEMENTS AND BUILDING UTILITIES. 25. ALL WORK SHALL BE DONE IN ACCORDANCE WITH THE 2020 MASSACHUSETTS ELECTRICAL CODE (MEC).
- 26. THE MEASUREMENT FROM ABOVE FINISHED FLOOR (AFF) SHALL BE TAKEN FROM THE FINISHED FLOOR SURFACE TO THE TOP OF WALL RECEPTACLES AND SWITCH BOXES, TO THE CENTER LINE OF WALL LIGHTING OUTLET BOXES, D THE TOP OF WALL MOUNTED EQUIPMENT ENCLOSURES. TO THE CENTER LINE OF THE TOP MOST SWITCH HANDLE, OR TO THE LOWEST SURFACE OF CEILING LIGHTING FIXTURES OTHER CEILING MOUNTED EQUIPMENT, UNLESS OTHERWISE NOTED ON ARCHITECTURAL DRAWINGS.
- 27. UNLESS OTHERWISE INDICATED, ALL CONDUCTORS ARE NO. 12 AWG. 28. CONDUIT SIZE FOR INDICATED CONDUCTORS SHALL BE BASED ON CHAPTER 9
- 29. THE CONTRACTOR MAY GROUP BRANCH CIRCUIT HOME RUN CONDUCTORS
- IN A SINGLE RACEWAY IN ACCORDANCE WITH NEC. 30. ALL BLANK COVER PLATES TO BE STAINLESS STEEL.
- 31. PROVIDE TRENCHING, SAND AND BACKFILL FOR ALL UNDERGROUND
- ELECTRICAL CONDUIT AND WIRING AS REQUIRED. 32. ALL MANUFACTURER'S WARRANTEES FOR EQUIPMENT AND MATERIALS
- PROVIDED TO BE TURNED OVER TO THE OWNER.
- 33. REFER TO ARCHITECTURAL DRAWINGS FOR WIRING DEVICE LOCATIONS AND
- MOUNTING HEIGHTS.
- 34. CONTRACTOR SHALL OBTAIN AND PAY FOR ALL UTILITY COMPANY CHARGES. 35. PROVIDE TEMPORARY SERVICE TO BUILDING AS REQUIRED DURING CONSTRUCTION

ELECTRICAL ABBREVIATIONS

A.F.F. ABOVE FINISHED FLOOR AMERICAN WIRE GAUGE CONDUIT CIRCUIT **EMERGENCY** FEET GROUNDED INTERRUPTING CAPACITY (KILOAMPERE) KILOVOLT-AMPERE KVA KW KILOWATT LTG LIGHTING NEC NATIONAL ELECTRIC CODE NEMA NATIONAL ELECTRICAL MANUFACTURERS ASS. NOT IN CONTRACT UNDERWRITER'S LABORATORY UTIL UTILITY VOLTS **VOLT-AMPERES**

WATTS

MECHANICAL GENERAL NOTES

- DRAWINGS ARE DIAGRAMMATIC. THEY INDICATE THE GENERAL ARRANGEMENT OF SYSTEMS AND WORK INCLUDED IN THE CONTRACT. DRAWINGS ARE NOT TO BE SCALED. ORIGINAL ARCHITECTURAL DRAWINGS AND DETAILS SHALL BE EXAMINED FOR EXACT LOCATION OF FIXTURES AND EQUIPMENT. WHERE THEY ARE NOT DEFINITELY LOCATED, THE INFORMATION SHALL BE OBTAINED FROM THE OWNER OR AUTHORIZED REPRESENTATIVE.
- UNLESS OTHERWISE INDICATED, PROVIDE COMPLETE AND OPERATIONAL MECHANICAL SYSTEMS INCLUDING ALL NECESSARY MATERIAL, LABOR, AND FOUIPMENT.
- UNLESS OTHERWISE INDICATED, PROVIDE CONTROL WIRING FOR ALL MECHANICAL SYSTEM EQUIPMENT. INSTALL PER N.E.C.
- 4. ALL EQUIPMENT AND MATERIAL SHALL BE LABELED AND LISTED AND INSTALLED IN ACCORDANCE WITH THEIR LISTING.
- THE CONTRACTOR SHALL OBTAIN ALL REQUIRED PERMITS AND ARRANGE FOR ALL REQUIRED INSPECTIONS IN ACCORDANCE WITH STATE AND LOCAL GOVERNING
- ALL WORK SHALL BE DONE WITH LICENSED WORKMEN IN ACCORDANCE WITH
- STATE AND LOCAL GOVERNING AUTHORITIES.
- THE TERM "INDICATED" SHALL MEAN "AS SHOWN ON CONTRACT DOCUMENTS (SPECIFICATIONS, DRAWINGS, AND RELATED ATTACHMENTS)."
- 8. THE TERM "PROVIDE" SHALL MEAN "TO FURNISH, INSTALL, AND CONNECT COMPLETELY.' 9. SUBMIT FOR REVIEW, DETAILED SHOP DRAWINGS OF ALL EQUIPMENT AND MATERIAL REQUIRED TO COMPLETE THE WORK. NO MATERIAL OR EQUIPMENT MAY BE DELIVERED TO THE JOBSITE OR INSTALLED UNTIL ACCEPTED SHOP DRAWINGS FOR THE PARTICULAR MATERIAL OR EQUIPMENT HAS BEEN APPROVED BY THE OWNER OR HIS AUTHORIZED REPRESENTATIVE. WHERE THE CONTRACTOR PROPOSES TO USE AN ITEM OF EQUIPMENT OTHER THAN THAT SPECIFIED OR DETAILED ON THE DRAWINGS. WHICH REQUIRES ANY REDESIGN OF THE STRUCTURE. PARTITIONS. FOUNDATIONS. PIPING. WIRING. OR ANY OTHER PART OF THE MECHANICAL, ELECTRICAL, OR ARCHITECTURAL LAYOUT, ALL SUCH REDESIGN AND ALL NEW DRAWINGS, AND DETAILING REQUIRED, THEREFORE, SHALL BE PREPARED AT THE CONTRACTOR'S EXPENSE AND IS SUBJECT TO THE REVIEW AND APPROVAL OF THE OWNER OR HIS AUTHORIZED REPRESENTATIVE. OWNER RESERVES THE
- 10. MECHANICAL PLANS AND DETAILS DO NOT SHOW ALL INTERFERENCES AND CONDITIONS, VISIBLE AND/OR HIDDEN, THAT MAY EXIST; THUS, REQUIRING THE CONTRACTOR TO INSPECT AND SURVEY THE SPACE BEFORE PERFORMING THE

RIGHT TO HAVE THE ARCHITECT OR ENGINEER OF HIS CHOICE PREPARE ANY

- 1. CONTRACTOR SHALL COORDINATE ELECTRICAL REQUIREMENTS OF MECHANICAL EQUIPMENT WITH DIVISION 16.
- 12. TURN OVER TO THE OWNER ALL MANUFACTURER'S WARRANTIES FOR EQUIPMENT AND MATERIALS PROVIDED.
- 13. BEFORE SELECTING MATERIAL AND EQUIPMENT AND PROCEEDING WITH WORK, INSPECT AREAS WHERE MATERIAL AND EQUIPMENT ARE TO BE INSTALLED TO INSURE SUITABILITY, AND CHECK NEEDED SPACE FOR PLACEMENT AND CLEARANCES.
- 4. BEFORE CUTTING OR DRILLING INTO BUILDING ELEMENTS, INSPECT AND LAYOUT
- WORK TO AVOID DAMAGING STRUCTURAL ELEMENTS AND BUILDING UTILITIES. 15. ALL WORK SHALL BE DONE IN ACCORDANCE WITH (THE LATEST ACCEPTED): A. 780 CMR
- B. ANSI STANDARDS

REDESIGN WORK.

- 16. LOCATE ALL EQUIPMENT WHICH REQUIRES SERVICING IN FULLY ACCESSIBLE POSITIONS. IF REQUIRED FOR BETTER ACCESSIBILITY, FURNISH ACCESS DOORS FOR THE PURPOSE. MINOR DEVIATIONS FROM DRAWINGS MAYBE MADE TO ALLOW FOR BETTER ACCESSIBILITY. ANY CHANGE SHALL BE SUBMITTED TO THE OWNER OR HIS AUTHORIZED REPRESENTATIVE FOR REVIEW.
- ASCERTAIN FROM EXAMINATION OF THE DRAWINGS, ANY SPECIAL TEMPORARY OPENINGS IN THE BUILDING REQUIRED FOR THE ADMISSION OF APPARATUS PROVIDED UNDER THIS DIVISION. NOTIFY THE OWNER ACCORDINGLY. IN THE EVENT OF FAILURE TO GIVE SUFFICIENT NOTICE TO THE CONTRACTOR IN TIME TO ARRANGE FOR OPENINGS DURING CONSTRUCTION, ASSUME ALL COSTS OF PROVIDING SUCH OPENINGS THEREAFTER. CONTRACTOR SHALL BE RESPONSIBLE FOR ALL ASSEMBLY AND DISASSEMBLY OF EQUIPMENT AS REQUIRED TO PLACE EQUIPMENT IN ITS FINAL LOCATION.
- 18. UNLESS OTHERWISE INDICATED, PROVIDE 14 GAUGE GALVANIZED PIPE SLEEVES TWO (2) SIZES LARGER THAN THE PIPE OR INSULATION WHERE SUCH ASSEMBLIES PENETRATE WALLS, PARTITIONS, FLOORS, OR STRUCTURAL MEMBERS.
- 19. ALL VOIDS BETWEEN PIPE SLEEVES AND PIPES SHALL BE FILLED WITH A FIRE TESTED AND APPROVED ELASTOMERIC CAULKING MATERIAL. 20. UNLESS OTHERWISE INDICATED, SUPPORT PIPES WITH HANGER SPACING IN
- ACCORDANCE WITH THE INTERNATIONAL MECHANICAL CODE. 21. CONTRACTOR SHALL MAKE ADEQUATE PROVISIONS FOR PIPE EXPANSION, CONTRACTION, SLOPE, AND ANCHORAGE.
- 22. CONTRACTOR TO BALANCE AIR SYSTEM AND PROVIDE TAB REPORT. TYPICAL.

PLUMBING GENERAL NOTES

- . NOTES BELOW ARE NOT INTENDED TO REPLACE SPECIFICATIONS. SEE SPECIFICATIONS FOR REQUIREMENTS IN ADDITION TO GENERAL NOTES.
- 2. PROVIDE FIXTURE SHUT-OFF VALVES AND P-TRAPS FOR ALL FIXTURES PROVIDED. PROVIDE SANITARY, WASTE AND DOMESTIC WATER PIPING AS REQUIRED FOR ALL FIXTURES PROVIDED.
- 3. REFER TO AND CAREFULLY CHECK ARCHITECTURAL, ELECTRICAL AND MECHANICAL DRAWINGS AND DETAILS. NOTING LOCATIONS WHERE WALLS. PARTITIONS, CEILINGS AND OTHER SURFACES ARE FURRED, LOCATION OF PIPE SLEEVES, LOCATIONS OF PIPE SHAFTS AND CONFLICTS WITH WORK OF OTHER TRADES AND ARRANGE WORK ACCORDINGLY. FURNISH ALL OFFSETS, FITTINGS, VALVES, DRAINS, ETC. REQUIRED TO MEET SUCH CONDITIONS.
- 4. DUE TO SCALE OF DRAWINGS, ALL REQUIRED OFFSETS, FITTINGS, VALVES, DRAINS, ETC. MAY NOT BE INDICATED.
- 5. ALL PIPING PASSING THROUGH FIRE RATED WALLS SHALL BE PROVIDED WITH SCHEDULE 40 STEEL PIPE SLEEVES AND SPACE BETWEEN EXTERIOR OF PIPE AND INTERIOR OF PIPE SLEEVE PACKED WITH A FIRE RATED MATERIAL EQUAL TO THE RATING OF THE WALL.
- 6. UNLESS OTHERWISE INDICATED, PROVIDE A COMPLETE AND OPERATIONAL MECHANICAL SYSTEM INCLUDING ALL NECESSARY MATERIAL, LABOR AND
- 7. CONTRACTOR SHALL OBTAIN AND PAY FOR ALL REQUIRED PERMITS AND ARRANGE FOR ALL REQUIRED INSPECTIONS IN ACCORDANCE WITH STATE
- AND LOCAL GOVERNING CODES. 8. THE TERM "PROVIDE" SHALL MEAN "TO FURNISH, INSTALL AND CONNECT
- 9. WHERE THE CONTRACTOR PROPOSES TO USE AN ITEM OF EQUIPMENT OTHER THAN THAT SPECIFIED OR DETAILED ON THE DRAWINGS WHICH REQUIRES ANY REDESIGN OF THE STRUCTURE. PARTITIONS, FOUNDATIONS, PIPING, WIRING OR ANY OTHER PART OF THE MECHANICAL, ELECTRICAL OR ARCHITECTURAL LAYOUT, ALL SUCH REDESIGN AND ALL NEW DRAWINGS AND DETAILING REQUIRED THEREFORE, SHALL BE PREPARED AT THE CONTRACTOR'S EXPENSE AND ARE SUBJECT TO THE REVIEW AND APPROVAL OF THE OWNER OR HIS AUTHORIZED REPRESENTATIVE. OWNER RESERVES THE RIGHT TO HAVE THE ARCHITECT OR ENGINEER OF HIS CHOICE PREPARE ANY REDESIGN WORK.
- 10. ALL WORK SHALL BE DONE WITH LICENSED WORKMEN IN ACCORDANCE WITH STATE AND LOCAL GOVERNING AUTHORITIES.
- 1. CONTRACTOR SHALL MAKE ADEQUATE PROVISIONS FOR PIPE SLOPE AND ANCHORAGE.
- 12. BEFORE CUTTING OR DRILLING INTO BUILDING ELEMENTS, INSPECT AND LAYOUT WORK TO AVOID DAMAGING STRUCTURAL ELEMENTS AND BUILDING UTILITIES.
- 13. ALL WORK SHALL BE DONE IN ACCORDANCE WITH THE LATEST ACCEPTED:
- A. 780 CMR B. ASTM & ANSI STANDARDS.

COMPLETELY."

- 14. CONTRACTOR SHALL BE RESPONSIBLE FOR REPAIR AND PAYMENT FOR ALL UTILITIES DAMAGED DURING CONSTRUCTION.
- 15. CONTRACTOR TO CONFIRM PIPE LOCATIONS, ELEVATIONS, AND SIZES
- BEFORE ANY WORK IS STARTED. IF ANY DISCREPANCIES ARE FOUND NOTIFY ENGINEER BEFORE PROCEEDING WITH WORK.
- 16. PROVIDE WATER SERVICE SHUT OFF VALVES ON WATER SUPPLY IMMEDIATELY ADJACENT TO PLUMBING FIXTURES.
- 17. PROVIDE SEISMIC BRACING OF ALL PLUMBING PIPES PER THE CONNECTICUT BUILDING CODE.
- 18. PROVIDE WATER HAMMER ARRESTERS FOR ALL FLUSH VALVES. SIZE AND LOCATE IN ACCORDANCE WITH MANUFACTURER'S RECOMMENDATIONS. 19. FOLLOW MANUFACTURER'S INSTRUCTIONS AND RECOMMENDATIONS FOR
- INSTALLATION OF PROVIDED EQUIPMENT. 20. ALL PIPES THAT PENETRATE WALLS, FLOORS AND CEILINGS IN FINISHED
- AREAS SHALL RECEIVE CHROME PLATED METAL ESCUTCHEONS.
- 21. ALL SHOP DRAWINGS OF INDIVIDUAL COMPONENTS ARE TO BE SUBMITTED AS A COMPLETE PACKAGE.
- 22. ALL SHOP DRAWINGS OF RELATED COMPONENTS SHALL BE SUBMITTED
- AS A COMPLETE PACKAGE.
- 23. ALL WORK IN INTERIOR FINISHED SPACES IS TO BE CONCEALED BEHIND WALLS, ABOVE CEILINGS, OR UNDER THE FLOOR. PROVIDE ALL NECESSARY CUTTING, PATCHING, REPAINTING AND/OR REPLACEMENT OF FINISHES AS REQUIRED TO PERFORM WORK.
- 24. WRITTEN REQUESTS FOR PLANNED SHUTDOWN OR INTERRUPTION OF BUILDING SERVICES. SYSTEMS OR EQUIPMENT SHALL BE MADE IN WRITING 72 HOURS PRIOR TO START OF THE REQUESTED SHUTDOWN PERIOD.
- 25. SUPPORT PIPING ABOVE SUSPENDED CEILING, FROM CONSTRUCTION ABOVE, AS CLOSE AS POSSIBLE TO BOTTOM OF SLABS, BEAMS, MAINTAINING MAXIMUM HEADROOM AT ALL TIMES.
- 26. PROVIDE CLEANOUTS PER PLUMBING CODE.
- 27. ISLE AND CORRIDOR WAYS THROUGH CONSTRUCTION AREAS WHICH ARE REQUIRED FOR EGRESS (NORMAL OR EMERGENCY) SHALL BE KEPT CLEAR OF MATERIAL, EQUIPMENT, & DEBRIS.
- 28. ALL WORK SHALL BE LICENSED WORKMAN IN ACCORDANCE WITH STATE AND LOCAL GOVERNING AUTHORITIES.

PLUMBING ABBREVIATIONS

- C.O. CLEANOUT DCW DOMESTIC COLD WATER SUPPLY DHW DOMESTIC HOT WATER SUPPLY
- DN DWH DOMESTIC WATER HEATER
- **EXPANSION TANK** F.C.O. FLOOR CLEANOUT
- FLOOR DRAIN GPH GALLONS PER HOUR
- JANITOR'S SINK LAV LAVATORY NFWH NON-FREEZE WALL HYDRANT

GALLONS PER MINUTE

- LIQUID PROPANE GAS NTS NOT TO SCALE
- PRV PRESSURE REDUCING VALVE
- SAN SANITARY

GPM

- TM THERMOSTATIC MIXING VALVE TYP TYPICAL
- VTR SANITARY VENT THROUGH ROOF WATER CLOSET

REVISIONS DESCRIPTION REV. DATE

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PROJECT TITLE

CONTRACT DOCUMENTS



SOUTH EGREMONT, MASSACHUSETTS

DRAWING TITLE

PLUMBING/MECHANICAL/ ELECTRICAL DETAILS, NOTES, SCHEDULES, SYMBOLS ABBREVIATIONS


JOB NO.	941 3694.01
PROJECT MANAGER	JAS
ENGINEER/DESIGNER	FB
DRAWN BY	BG
SCALE	AS NOTED
DATE	OCTOBER 7, 2021

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PME-3



REVISIONS

REV. DESCRIPTION DATE
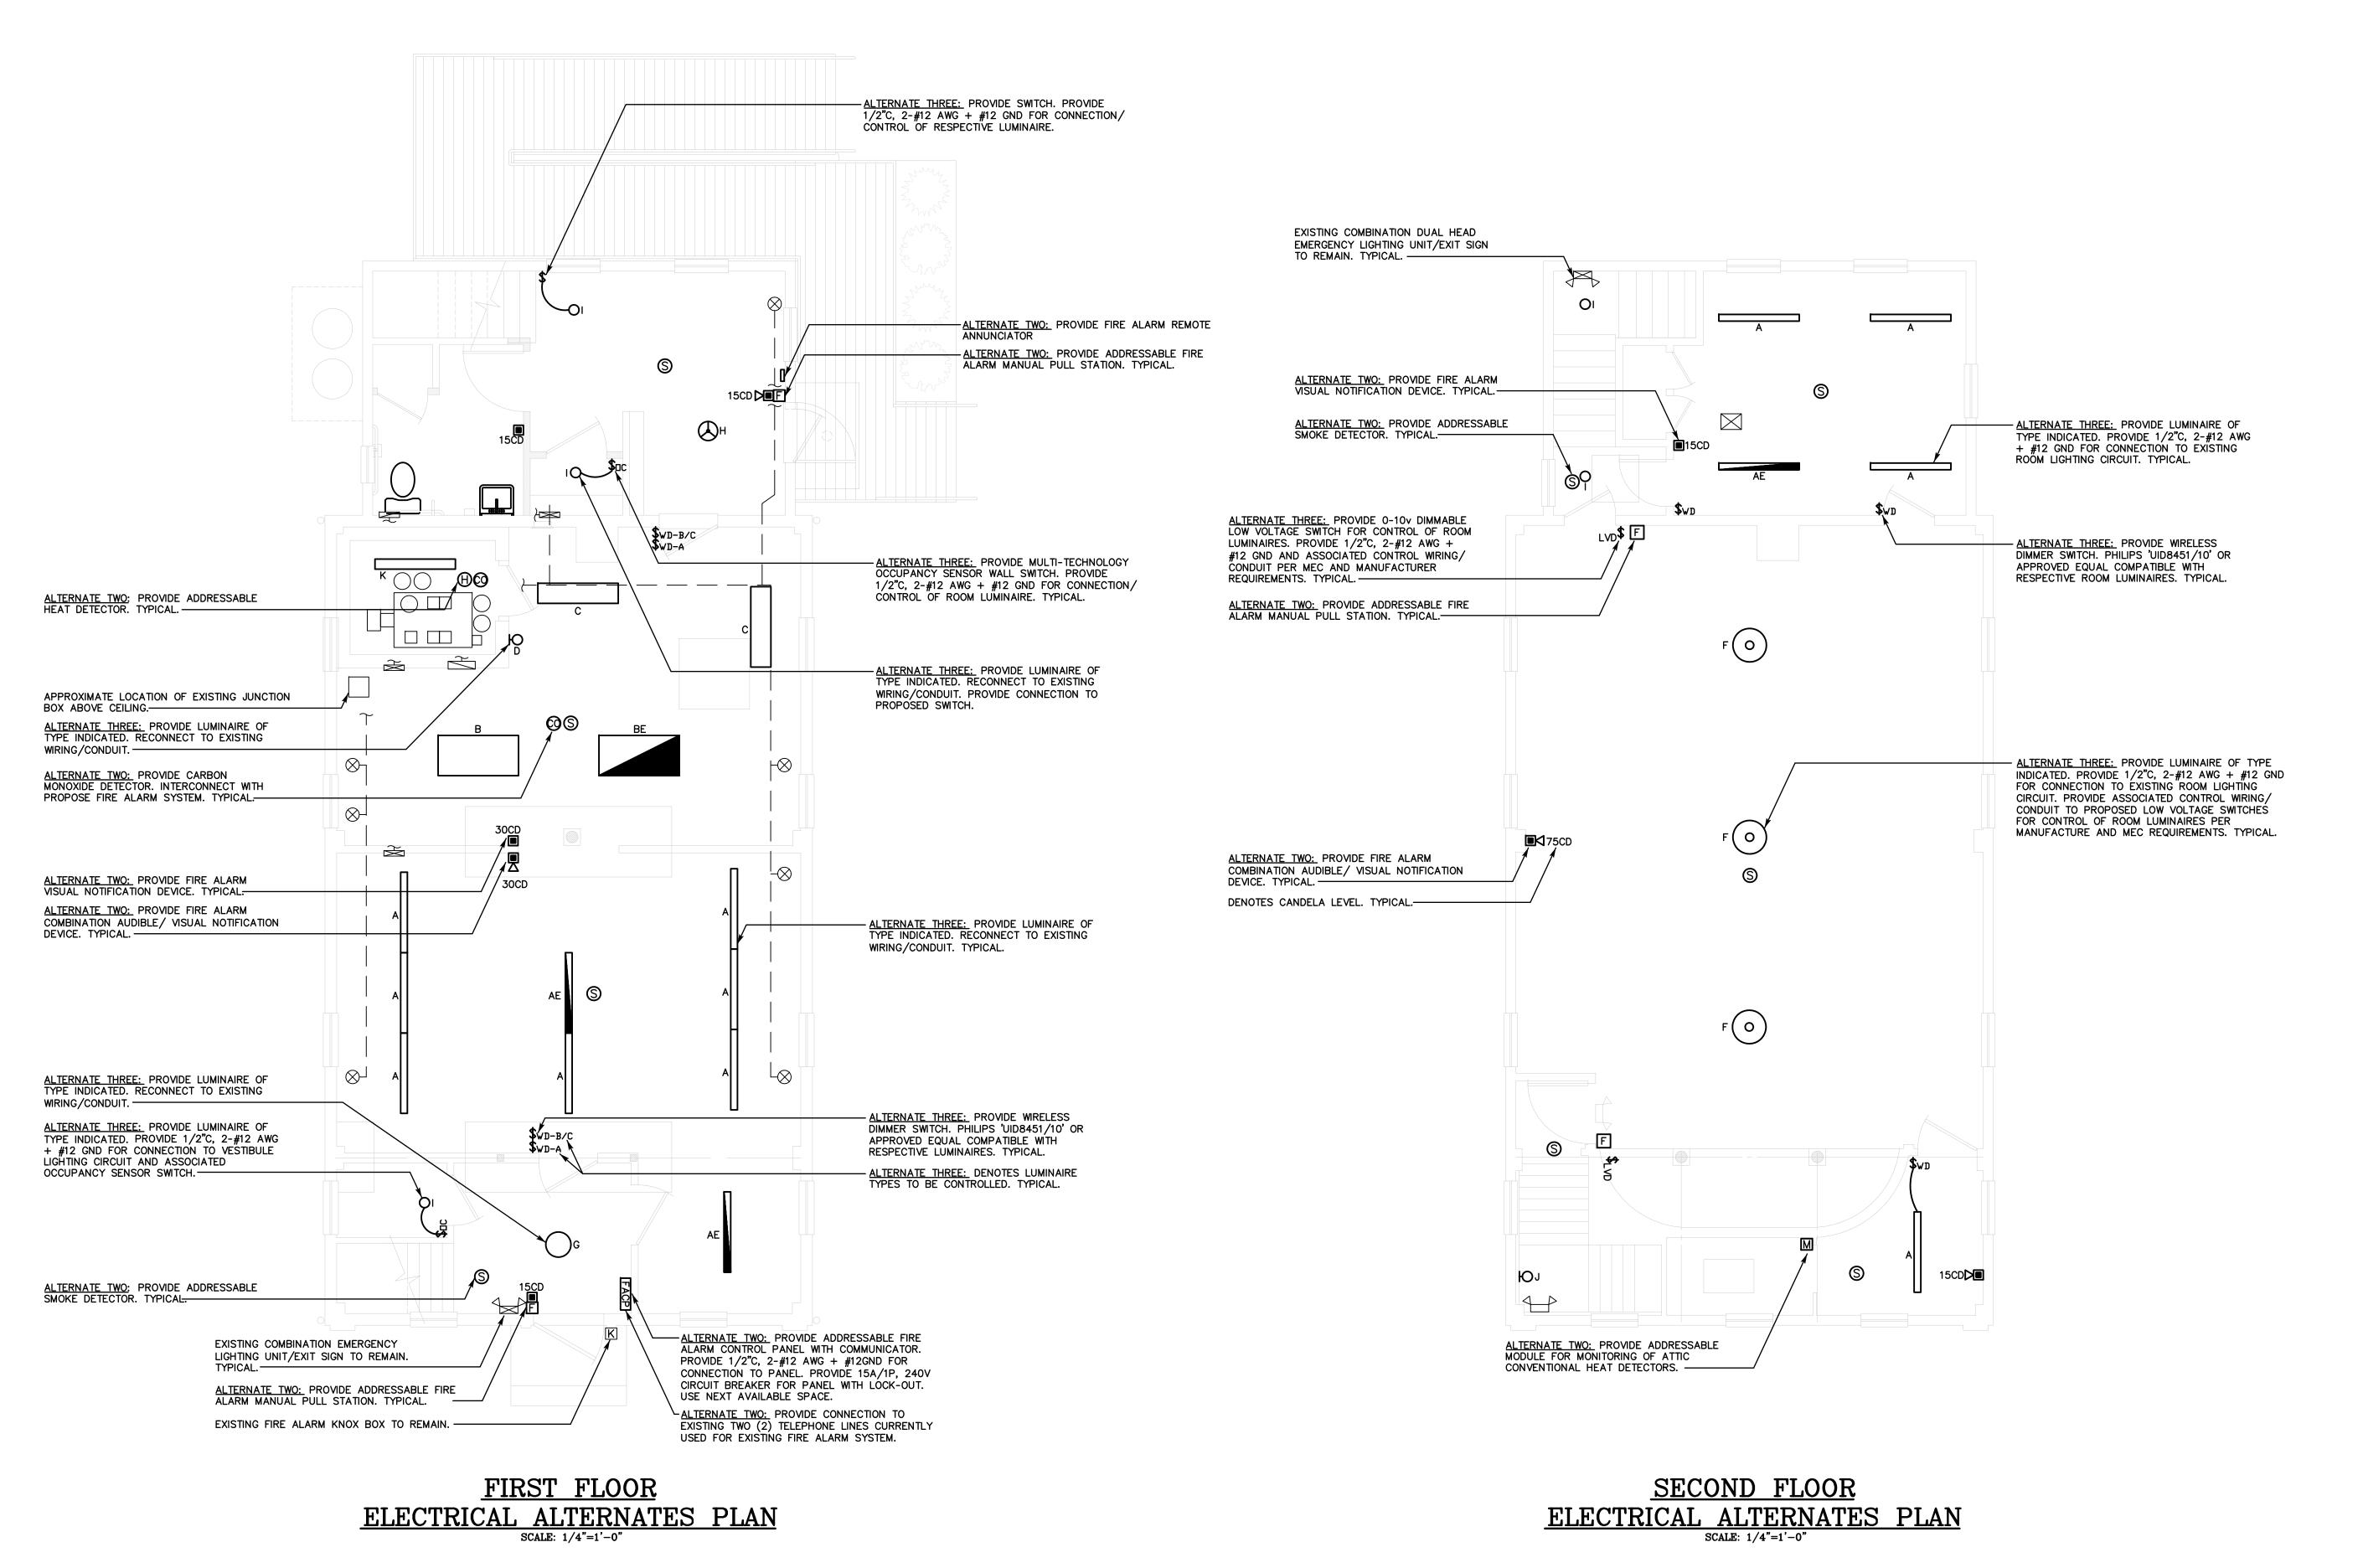
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PROJECT TITLE

CONTRACT DOCUMENTS

MOUNT EVERETT ACADEMY ADA AND CODE COMPLIANCE

SOUTH EGREMONT, MASSACHUSETTS

DRAWING TITLE

FIRTS & SECOND FLOOR ELECTRICAL ALTERNATES PLANS


JOB NO.	941 3694.01
PROJECT MANAGER	JAS
ENGINEER/DESIGNER	FB
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CAD FILE: EGREMONT	ACADEMY E-1 ALT

DRAWING NO.

E-1 ALT

ALTERNATE #3 NOTE:

CONTRACTOR SHALL OBTAIN AND PAY FOR SERVICES OF FACTORY REPRESENTATIVE TO PROGRAM RESPECTIVE LUMINAIRES. SEE SPECIFICATIONS FOR FURTHER REQUIREMENTS. TYPICAL.

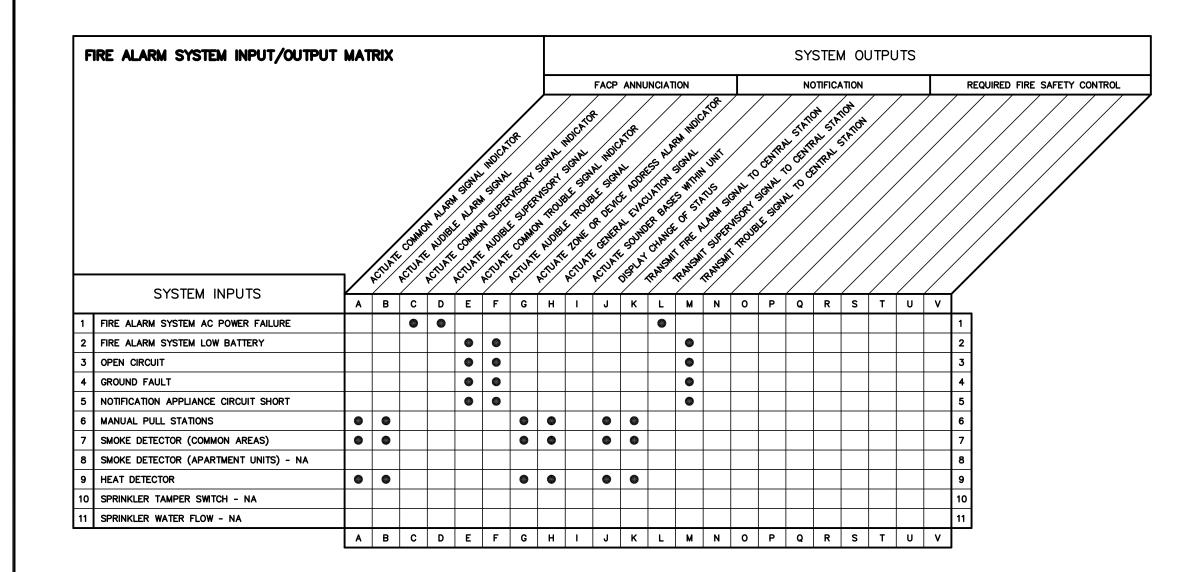

SEQUENCE OF OPERATIONS

FIRE PROTECTION SYSTEMS TO BE INSTALLED:

AS PART OF THIS SCOPE OF WORK, A NEW FIRE ALARM SYSTEM IS BEING INSTALLED PER NFPA 72 FOR BUILDING. THE FIRE ALARM CONTROL PANEL (FACP) SHALL BE NEW, ADDRESSABLE TYPE. THE PROPOSED FACP SHALL MONITOR AND CONTROL THE FIRE ALARM SYSTEM DETECTION, INITIATION AND NOTIFICATION DEVICES.

DETECTION AND INITIATION DEVICES SHALL INCLUDE THE FOLLOWING:


- SMOKE DETECTOR WHEN ACTIVATED SHALL SEND SIGNAL TO FACP AND SOUND A GENERAL ALARM.
 HEAT DETECTOR WHEN ACTIVATED SEND SIGNAL TO FACP AND SOUND GENERAL ALARM.
 MANUAL PULL STATION WHEN ACTIVATED SHALL SEND SIGNAL TO FACP AND SOUND A GENERAL ALARM.
 CARBON MONOXIDE DETECTOR WHEN ACTIVATED SHALL SEND SIGNAL TO FACP ANNUNCIATING ALARM.

ANNUNCIATION DEVICES SHALL INCLUDE THE FOLLOWING:

- STROBES AND COMBINATION HORN/STROBES TO NOTIFY OCCUPANTS OF GENERAL ALARM.
 POWER FOR EACH DEVICE WILL BE SUPPLIED FROM THE FACP SYSTEM, INCLUSIVE OF EMERGENCY BATTERY POWER SYSTEM BACK-UP POWER.

SYSTEM MONITORING:

- THE FACP IS TO BE ADDRESSABLE AND WILL MONITOR STATUS OF EACH SYSTEM DEVICE.
 THE FACP WILL CONTAIN A LOCAL ANNUNCIATOR PANEL FOR
- THE FACP WILL CONTAIN A LOCAL ANNONCATOR PANEL FOR DENOTING DEVICE(S) AND SYSTEM STATUS.
 THE FACP WILL HAVE A BATTERY BACK-UP SYSTEM FOR CONSISTENT OPERATION.
 THE FACP SHALL SIGNAL TO CENTRAL SYSTEM MONITORING AND DISPATCH UNDER A TROUBLE AND/OR ALARM CONDITION.
- ALARM DISPATCH WE BE UNDER THE FOLLOWING CONDITIONS:
- O ACTIVATION OF A HEAT DETECTION DEVICE.
 O ACTIVATION OF A SMOKE DETECTION DEVICE.
 O ACTIVATION OF A MANUAL PULL STATION.
- TROUBLE DISPATCH WE BE UNDER THE FOLLOWING CONDITIONS:
- ACTIVATION OF CARBON MONOXIDE DETECTION DEVICE.
 SYSTEM DEVICE FAILURES.
 SYSTEM CONNECTION FAILURES.

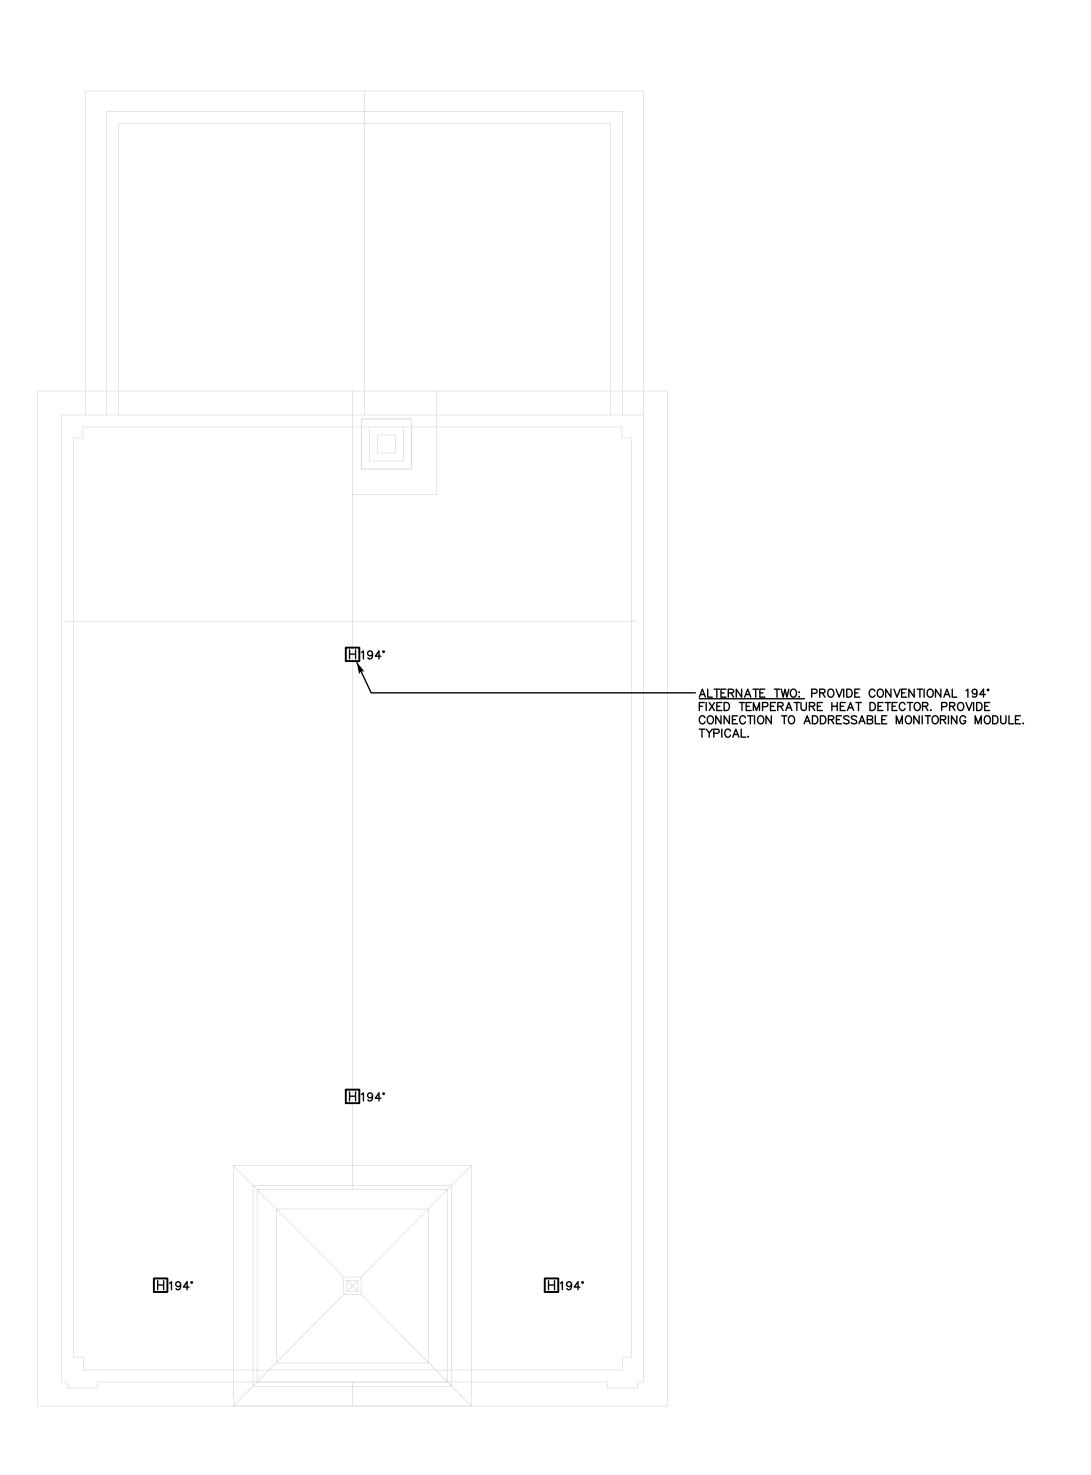

ATTIC
ELECTRICAL ALTERNATE PLAN

ALTERNATE THREE - ATTIC LIGHTING NOTE: CONTRACTOR SHALL PROVIDE LIGHT SWITCH AT EACH ATTIC ENTRY POINT. PROVIDE 1/2"C, 2-#12 AWG + #12 GND FOR CONNECTION TO PANEL. PROVIDE 20A/1P, 240V CIRCUIT BREAKER FOR PANEL. USE NEXT AVAILABLE SPACE.

REVISIONS		
REV.	DESCRIPTION	DAT

CONSULTANT:

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PROJECT TITLE

CONTRACT DOCUMENTS



SOUTH EGREMONT, MASSACHUSETTS

DRAWING TITLE

ATTIC ELECTRICAL ALTERNATE PLAN

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PROJECT MANAGER	JAS
ENGINEER/DESIGNER	FB
DRAWN BY	BG
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